


ROPOSED CONCRETE IOINT LAYOUT PLAN 400 BLOCK

CITY OF MARSHALL, TX.

YES ENGINEERING, INC.Texas Registered Engineering Firm F-1465
2126 Alpine St. Longview, TX 75601-3401
Tel.: (903) 758-2010 • Fax: (903) 758-2099

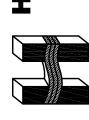




DRAWN BY: R.L.C.
CHECKED BY: S.R.H.
DATE: SEPT. 2023
SCALE: 1"=10'
JOB NO.: MA-21-01
MA-22-04

SHEET

OF **27** SHEETS

SHEET


of **27** SHEETS

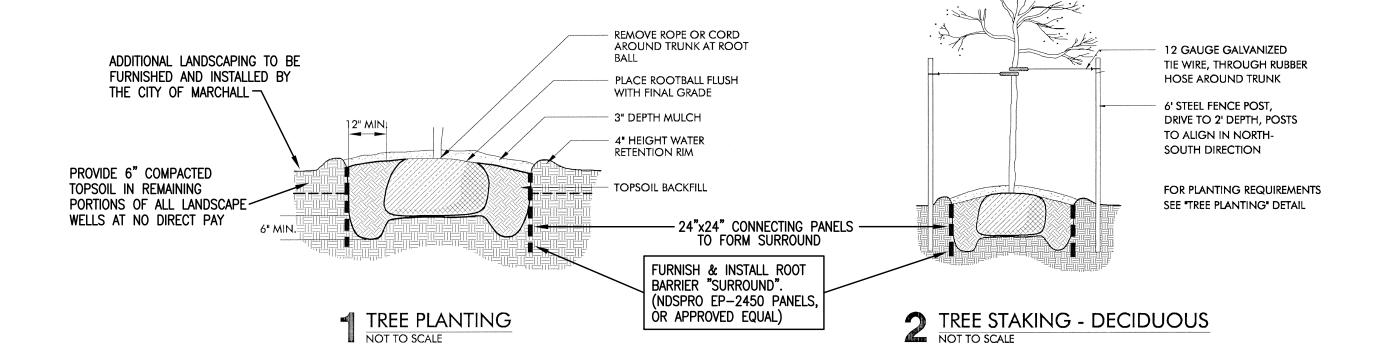

PLANT LEGEND

Qty	. Botanical Name	Common Name	Root Ball	Size	Remarks
Т	REES				
10	Cercis canadensis "Merlot"	Merlot Redbud	B & B	3"-4" Cp minimum	Matched


Cp = Caliper, Ht = Height, Sp = Spread

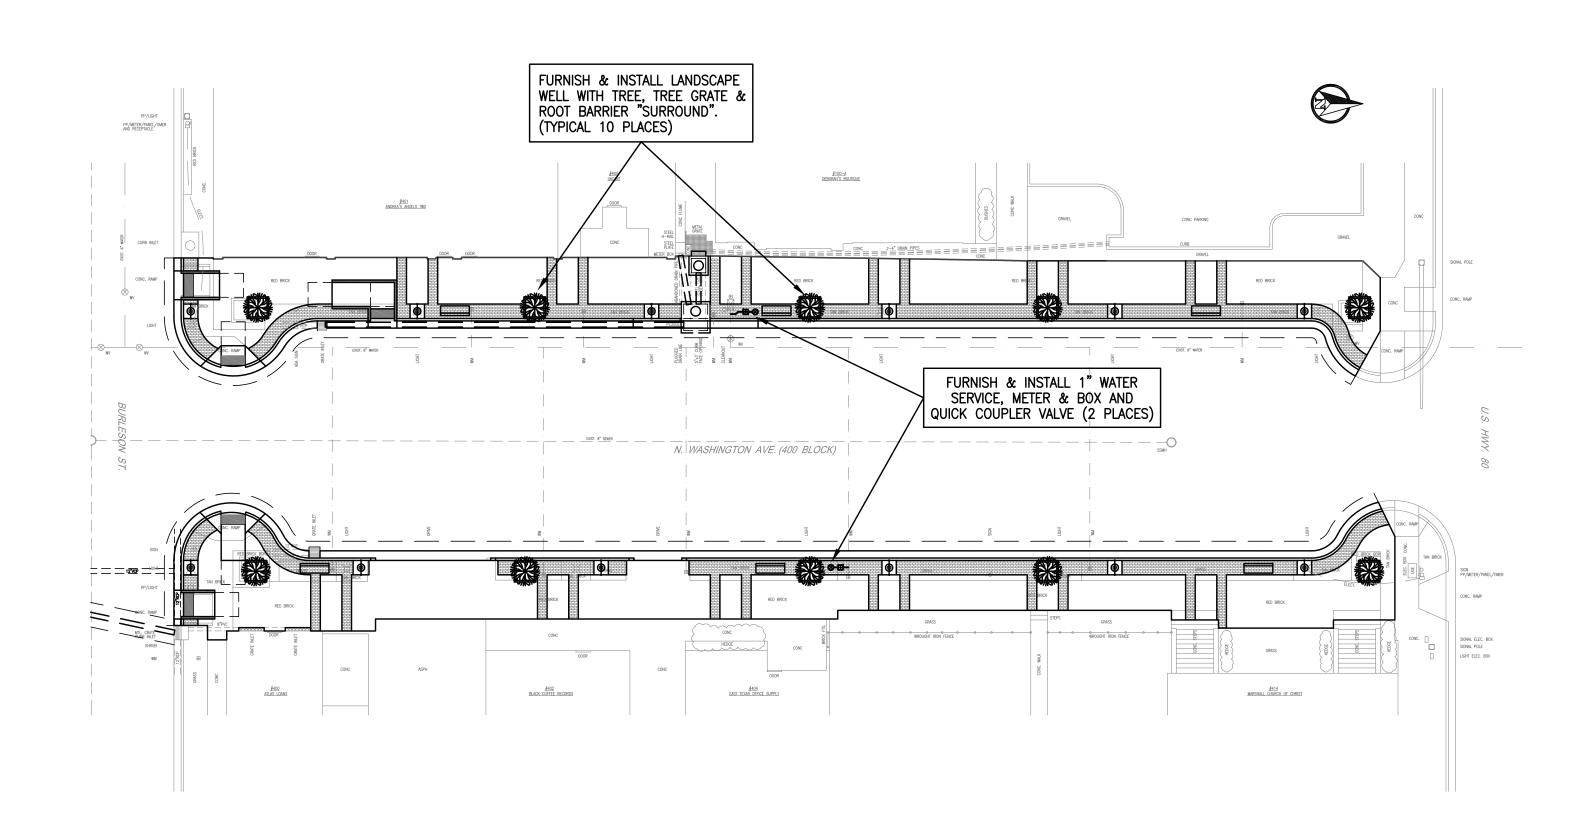

PLANTING NOTES

1. THIS SITE HAS A TREMENDOUS AMOUNT OF SUBTERRANEOUS UTILITIES AND PIPELINES. SOME OF THESE HAVE BEEN LOCATED ON THE SURVEY AND ARE REFLECTED IN THESE DRAWINGS. IT IS THE CONTRACTOR'S RESPONSIBILITY, HOWEVER, TO HAVE ALL UTILITIES AND PIPELINES LOCATED BEFORE INSTALLING LANDSCAPE MATERIALS. IF THERE ARE CONFLICTS THE ENGINEER SHALL BE CONTACTED IMMEDIATELY.

- 2. CONTRACTOR SHALL VERIFY ALL LANDSCAPE MATERIAL QUANTITIES AND SHALL REPORT ANY DISCREPANCIES TO THE ENGINEER PRIOR TO INSTALLATION.
- 3. CONTRACTOR SHALL MAKE NO SUBSTITUTIONS WITHOUT THE APPROVAL OF THE ENGINEER.
- 4. CONTRACTOR SHALL STAKE LAYOUT PLAN IN THE FIELD AND SHALL HAVE THE LAYOUT APPROVED BY THE ENGINEER BEFORE PROCEEDING WITH THE INSTALLATION.
- 5. ALL LANDSCAPE AREAS SHALL BE MULCHED WITH 3" OF SHREDDED HARDWOOD MULCH. MUCH TO BE APPROVED BY ENGINEER PRIOR TO PLACEMENT. ALL MULCH TO BE RAKED EVEN TO THE SPECIFIED DEPTH & WATER SETTLED. THIS WORK SHALL BE SUBSIDIARY TO LANDSCAPE WORK.
- 6. CONTRACTOR SHALL GUARANTEE ALL WORK AND PLANT MATERIAL FOR PERIOD STATED IN SPECIFICATIONS.
- 7. ANY PLANT MATERIAL WHICH DIES DURING THE GUARANTEE PERIOD SHALL BE REMOVED IMMEDIATELY AND REPLACED BY THE CONTRACTOR DURING THE NEXT NORMAL PLANTING SEASON IN ACCORDANCE WITH THE SPECIFICATIONS AND LOCAL PRACTICE.
- 8. CONTRACTOR SHALL BE RESPONSIBLE FOR MAINTENANCE OF THE PLANTS. SEE SPECIFICATIONS FOR MAINTENANCE PERIOD.
- 9. ALL PLANT NAMES ON THE PLANT LIST SHALL CONFORM TO HORTICULTURAL NOMENCLATURE AS SET FORTH IN HORTUS III OR IN DATASCAPE, 1994 EDITION AND ALL SUPPLEMENTS.
- 10. ALL PLANT MATERIAL SHALL MEET THE MINIMUM SPECIFICATIONS IN THE "AMERICAN STANDARD FOR NURSERY STOCK" (ANSI Z60.1-1990 OR LATEST REVISION) SPONSORED BY THE AMERICAN ASSOCIATION OF NURSERYMEN, AND BE FREE OF PLANT DISEASES AND PEST. THE PLANTS SHALL BE OF TYPICAL FORM FOR THE SPECIES AND HAVING A HEALTHY, WELL BRANCHED ROOT SYSTEM.
- 11. SIZES INDICATED ON THE PLANT LIST ARE THE MINIMUM ACCEPTABLE SIZE. IN NO CASE WILL SIZES LESS THAN THE SPECIFIED SIZES BE ACCEPTED.
- 12. PLANTS SHALL BE PRUNED ONLY IN ACCORDANCE WITH STANDARD SPECIFICATIONS.
- 13. THE CONTRACTOR SHALL BE RESPONSIBLE FOR ANY COORDINATION WITH OTHER RELATED SITE WORK BEING PERFORMED BY OTHER CONTRACTORS AS REQUIRED TO ACCOMPLISH SITE CONSTRUCTION OPERATIONS.
- 14. THE PLANTING OF ANY PLANT MATERIAL WILL INCLUDE AS SUBSIDIARY ITEMS: MULCH, STAKES AND ANY OTHER ELEMENTS NECESSARY TO INSTALL AS DETAILED.
- 15. THE CONTRACTOR SHALL BE RESPONSIBLE FOR INSURING THE TREE PITS ARE EXCAVATED TO TWICE THE ROOT BALL SIZE.

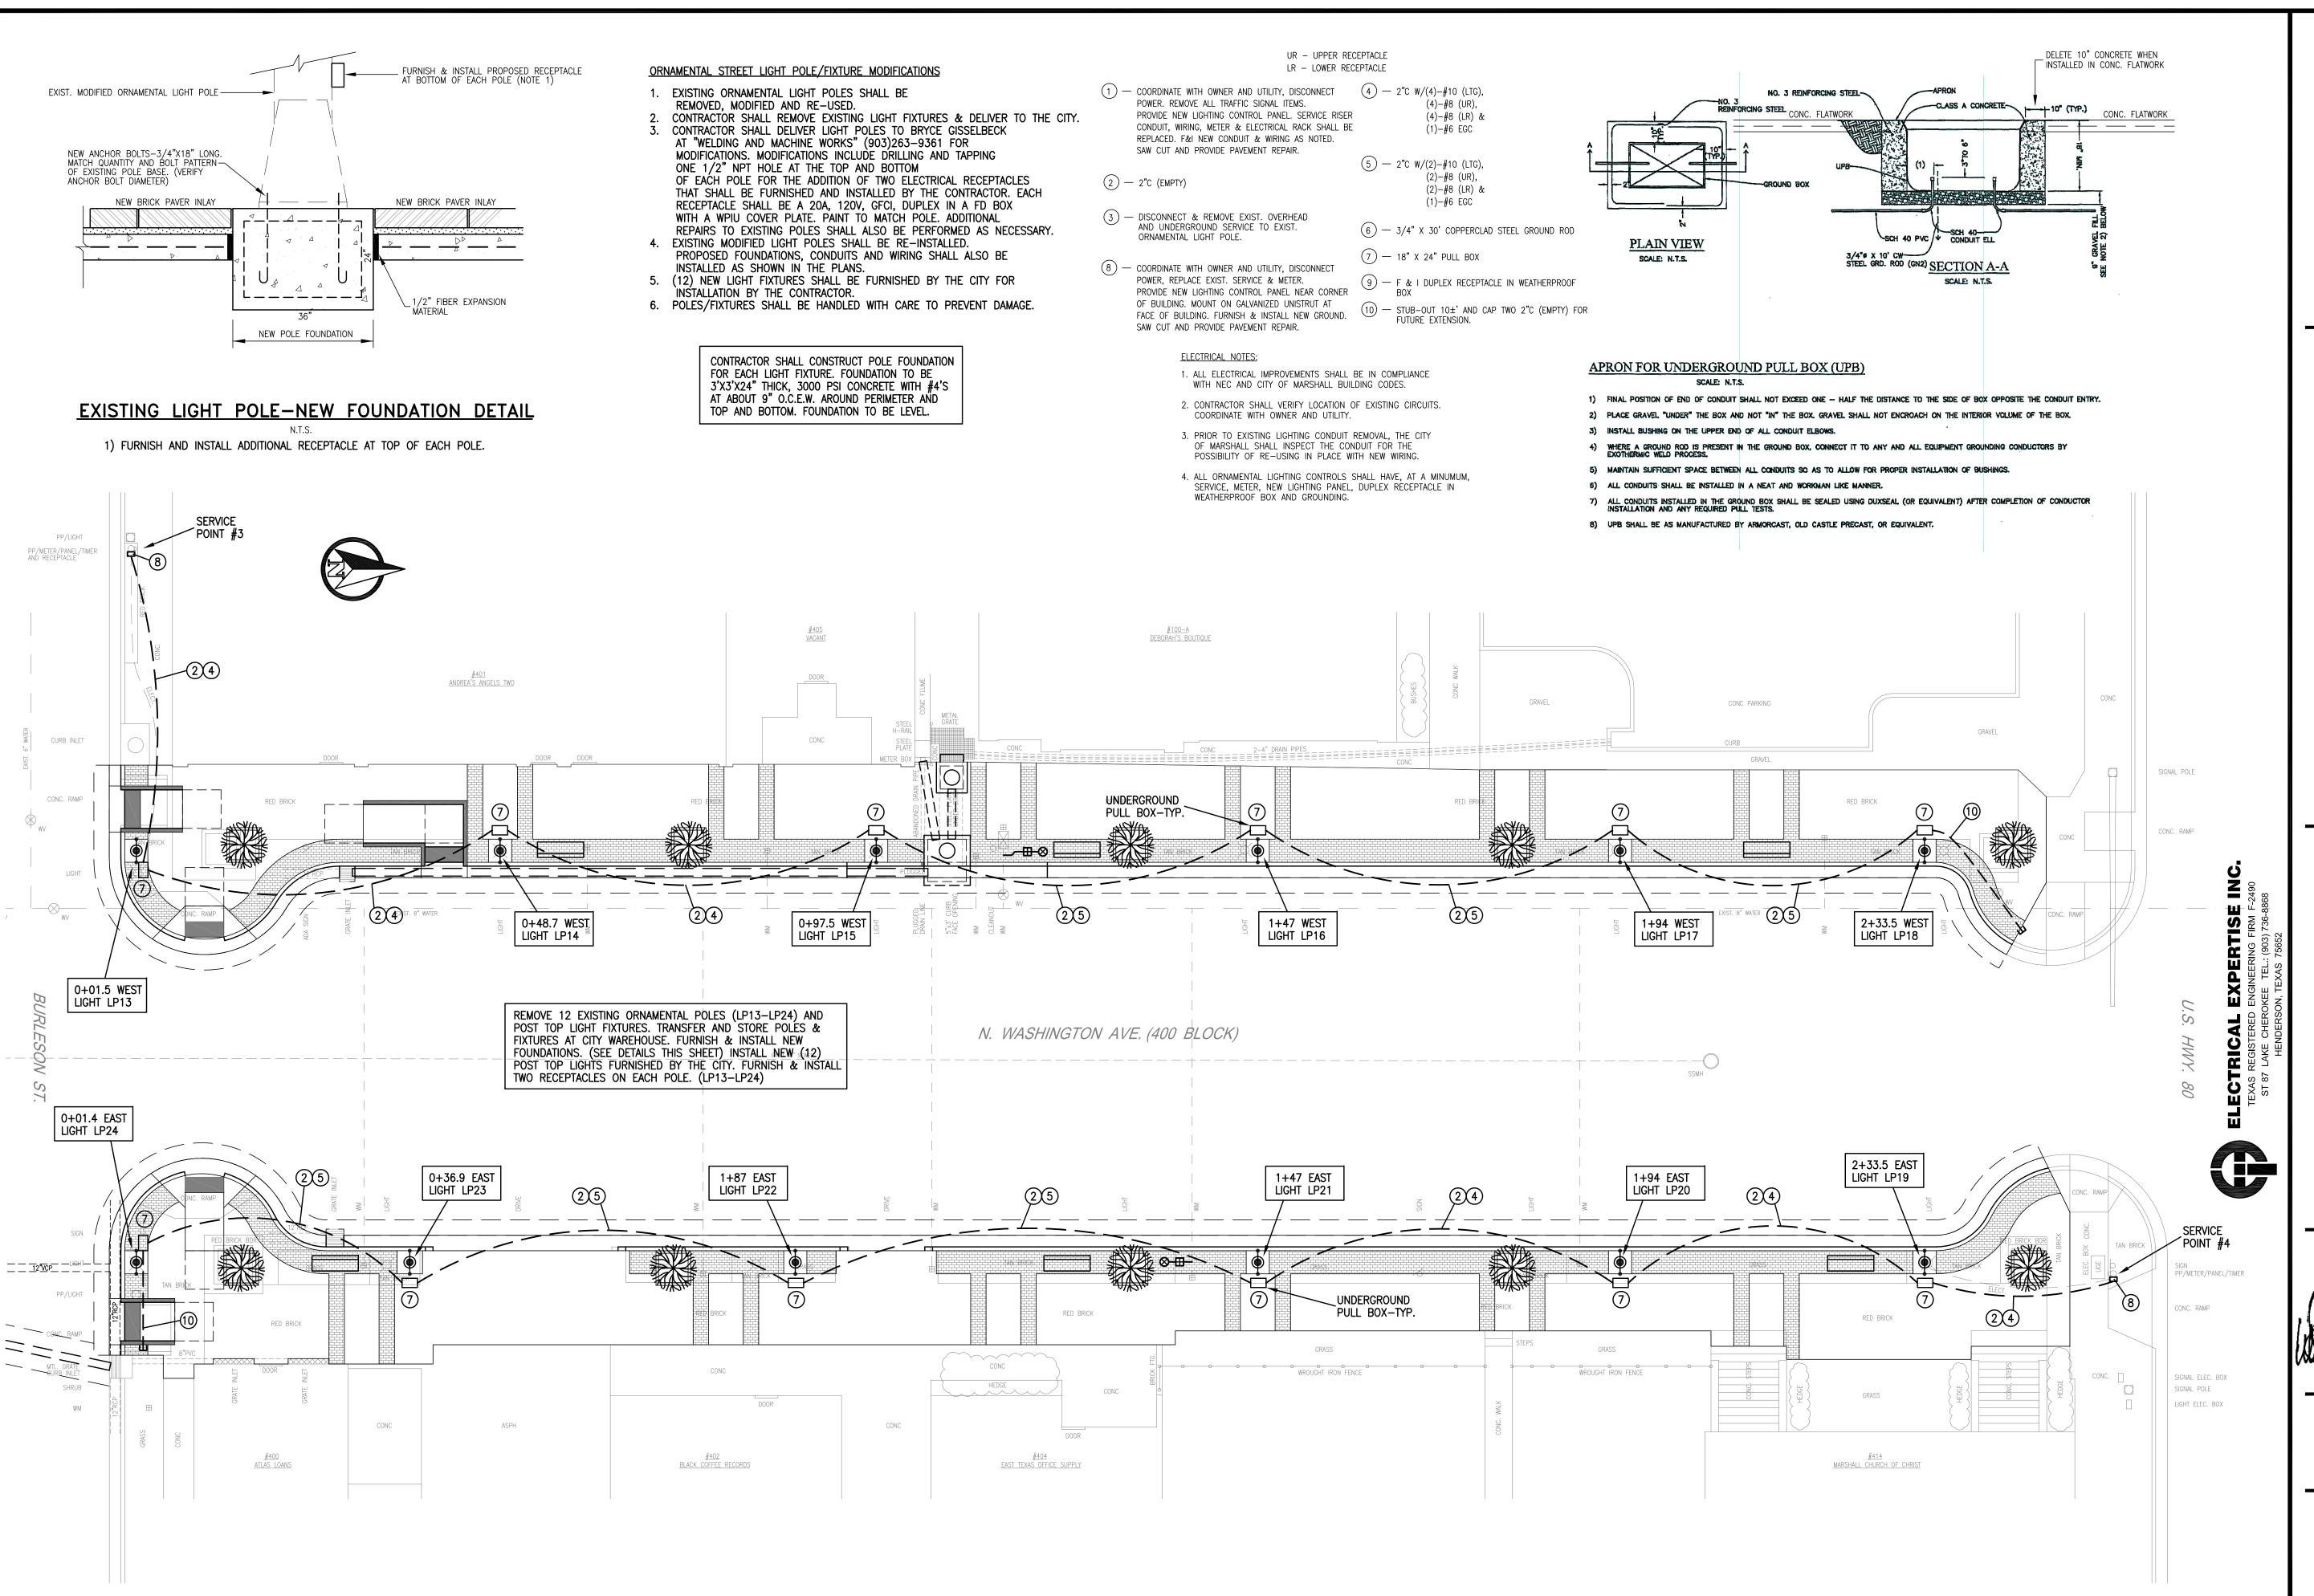



CHECKED BY : S.R.H. DATE : **SEPT. 2023** 1"=10" MA-21-01 MA-22-04 JOB NO.:

OF **27** SHEETS

CURB RAMPS

GENERAL NOTES

- 1. Install a curb ramp or blended transition at each pedestrian street crossing.
- 2. All slopes shown are maximum allowable. Cross slopes of 1.5% and lesser running should be used. Adjust curb ramp length or grade of approach sidewalks as directed.
- 3. Maximum allowable cross slope on sidewalk and curb ramp surfaces is 2%.
- 4. The minimum sidewalk width is 5'. Where the sidewalk is adjacent to the back of curb. a 6' sidewalk width is desirable. Where a 5' sidewalk cannot be provided due to site constraints, sidewalk width may be reduced to 4' for short distances. 5'x 5' passing areas at intervals not to exceed 200' are required.
- 5. Turning Spaces shall be 5'x 5' minimum. Cross slope shall be maximum 2%.
- 6. Clear space at the bottom of curb ramps shall be a minimum of 4'x 4' wholly contained within the crosswalk and wholly outside the parallel vehicular travel path.
- 7. Provide flared sides where the pedestrian circulation path crosses the curb ramp. Flared sides shall be sloped at 10% maximum, measured parallel to the curb. Returned curbs may be used only where pedestrians would not normally walk across the ramp, either because the adjacent surface is planted, substantially obstructed, or otherwise protected.
- 8. Additional information on curb ramp location, design, light reflective value and texture may be found in the latest draft of the Proposed Guidelines for Pedestrian Facilities in the Public Right of Way (PROWAG) as published by the U.S. Architectural and Transportation Barriers Compliance Board (Access Board).
- 9. To serve as a pedestrian refuge area, the median should be a minimum of 6' wide, measured from back of curbs. Medians should be designed to provide accessible passage over or through them.
- 10. Small channelization islands, which do not provide a minimum $5' \times 5'$ landing at the top of curb ramps, shall be cut through level with the surface of the street.
- 11. Crosswalk dimensions, crosswalk markings and stop bar locations shall be as shown elsewhere in the plans. At intersections where crosswalk markings are not required, curb ramps shall align with theoretical crosswalks unless otherwise directed.
- 12. Provide curb ramps to connect the pedestrian access route at each pedestrian street crossing. Handrails are not required on curb ramps.
- 13. Curb ramps and landings shall be constructed and paid for in accordance with Item 531 "Sidewalks".
- 14. Place concrete at a minimum depth of 5" for ramps, flares and landings, unless otherwise directed.
- 15. Furnish and install No. 3 reinforcing steel bars at 18" o.c. both ways, unless otherwise directed.
- 16. Provide a smooth transition where the curb ramps connect to the street.
- 17. Curbs shown on sheet 1 within the limits of payment are considered part of the curb ramp for payment, whether it is concrete curb, gutter, or combined curb and gutter.
- 18. Existing features that comply with applicable standards may remain in place unless otherwise shown on the plans.

DETECTABLE WARNING MATERIAL

- 19. Curb ramps must contain a detectable warning surface that consists of raised truncated domes complying with PROWAG. The surface must contrast visually with adjoining surfaces, including side flares. Furnish and install an approved cast-in-place dark brown or dark red detectable warning surface material adjacent to uncolored concrete, unless specified elsewhere in the plans.
- 20. Detectable Warning Materials must meet TxDOT Departmental Materials Specification DMS 4350 and be listed on the Material Producer List. Install products in accordance with manufacturer's specifications.
- 21. Detectable warning surfaces must be firm, stable and slip resistant.
- 22. Detectable warning surfaces shall be a minimum of 24 inches in depth in the direction of pedestrian travel, and extend the full width of the curb ramp or landing where the pedestrian access route enters the street.
- 23. Detectable warning surfaces shall be located so that the edge nearest the curb line is at the back of curb and neither end of that edge is greater than 5 feet from the back of curb. Detectable warning surfaces may be curved along the corner radius.
- 24. Shaded areas on Sheet 1 of 4 indicate the approximate location for the detectable warning surface for each curb ramp type.

DETECTABLE WARNING PAVERS (IF USED)

- 25. Furnish detectable warning paver units meeting all requirements of ASTM C-936, C-33. Lay in a two by two unit basket weave pattern or as directed.
- 26. Lay full-size units first followed by closure units consisting of at least 25 percent (25%) of a full unit. Cut detectable warning paver units using a power saw.

SIDEWALKS

- 27. Provide clear ground space at operable parts, including pedestrian push buttons. Operable parts shall be placed within unobstructed reach range specified in PROWAG section R406.
- 28. Place traffic signal or illumination poles, ground boxes, controller boxes, signs, drainage facilities and other items so as not to obstruct the pedestrian access route or clear ground space.
- 29. Street grades and cross slopes shall be as shown elsewhere in the plans.
- 30. Changes in level greater than 1/4 inch are not permitted.
- 31. The least possible grade should be used to maximize accessibility. The running slope of sidewalks and crosswalks within the public right of way may follow the grade of the parallel roadway. Where a continuous grade greater than five percent (5%) must be provided, handrails may be desirable to improve accessibility. Handrails may also be needed to protect pedestrians from potentially hazardous conditions. If provided, handrails shall comply with PROWAG R409.
- 32. Handrail extensions shall not protrude into the usable landing area or into intersecting pedestrian routes.
- 33. Driveways and turnouts shall be constructed and paid for in accordance with Item "Intersections, Driveways and Turnouts". Sidewalks shall be constructed and paid for in accordance with Item, "Sidewalks".
- 34. Sidewalk details are shown elsewhere in the plans.


SIDE FLARE

(TYP)

NO. 3 REBAR AT 18" (MAX) ON-CENTER-


BOTH WAYS OR AS DIRECTED


DETECTABLE WARNING PEDESTRIAN TRAVEL SURFACE DIRECTION

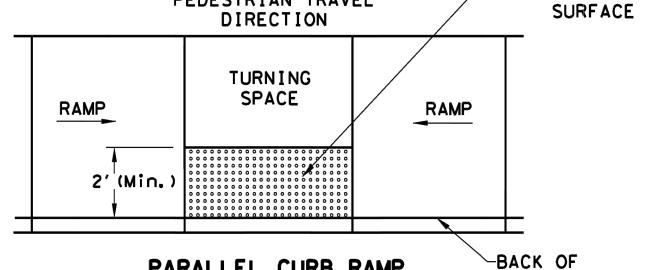

PARALLEL CURB RAMP TYPICAL PLACEMENT OF DETECTABLE WARNING SURFACE ON LANDING AT STREET EDGE.

DETECTABLE WARNING SURFACE DETAILS

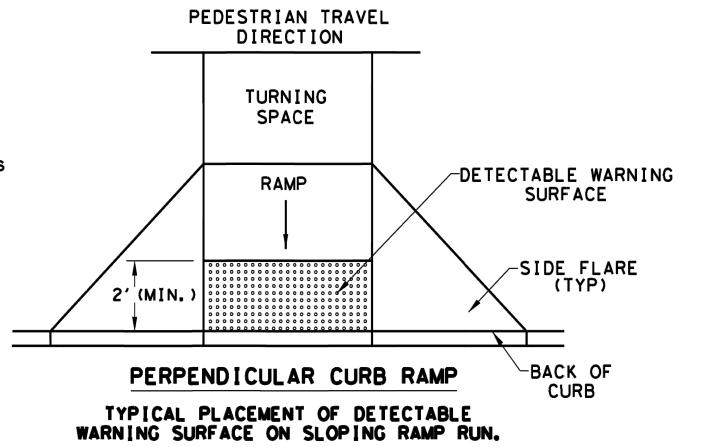

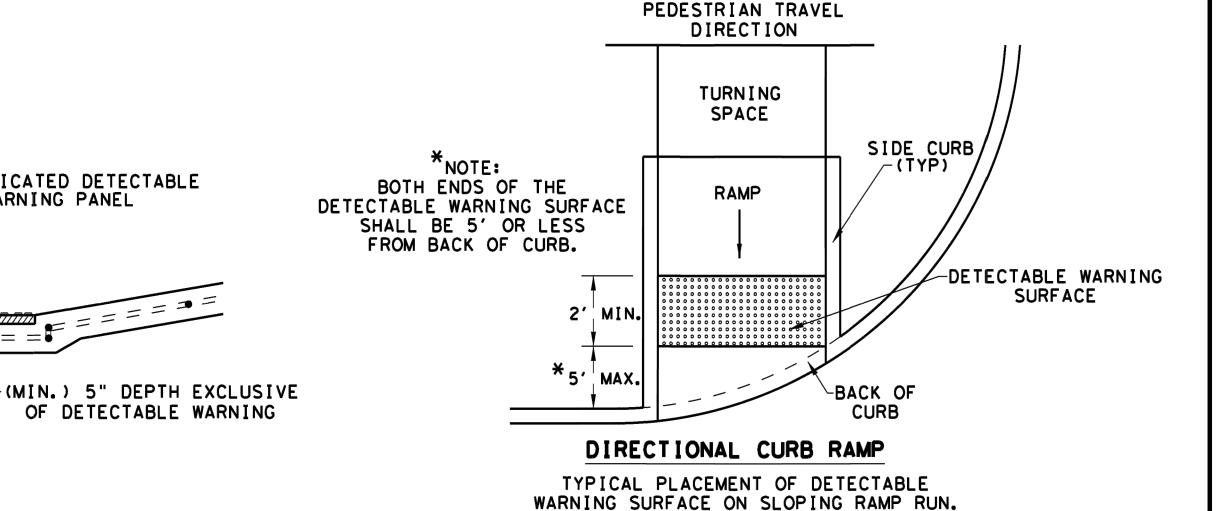

SECTION VIEW DETAIL CURB RAMP AT DETECTIBLE WARNINGS

DETECTABLE WARNING PAVER | PREFABRICATED DETECTABLE

WARNING PANEL

NOTE:
PED-18, SHEETS 1 THRU 4 ARE INTENDED TO BE USED AS FOR PEDESTRIAN FACILITIES, APPROX, INFORMATION FOR THE CONSTRUCTION OF THESE FACILITIES ARE SHOWN ELSEWHERE IN THE PLANS. ALL ADA/TAS REGULATIONS MUST APPLY

WITH TRUNCATED DOMES

CLASS A CONCRETE - SHALL-

CONFORM TO APPLICABLE

SPECIFICATIONS

ALL EXPOSED NEW CONCRETE SURFACES SHALL HAVE A LIGHT BROOM FINISH.


SHEET 2 OF 4




CURB RAMPS


PED-18

FILE: ped18	DN: T×	DOT	DW: VP	CK: KM		CK: PK & JG
© TxDOT: MARCH, 2002	CONT	SECT	JOB			HIGHWAY
REVISIONS REVISED 08,2005						
REVISED 06,2012 REVISED 01.2018	DIST	COUNTY				SHEET NO.
			'			22 of 27

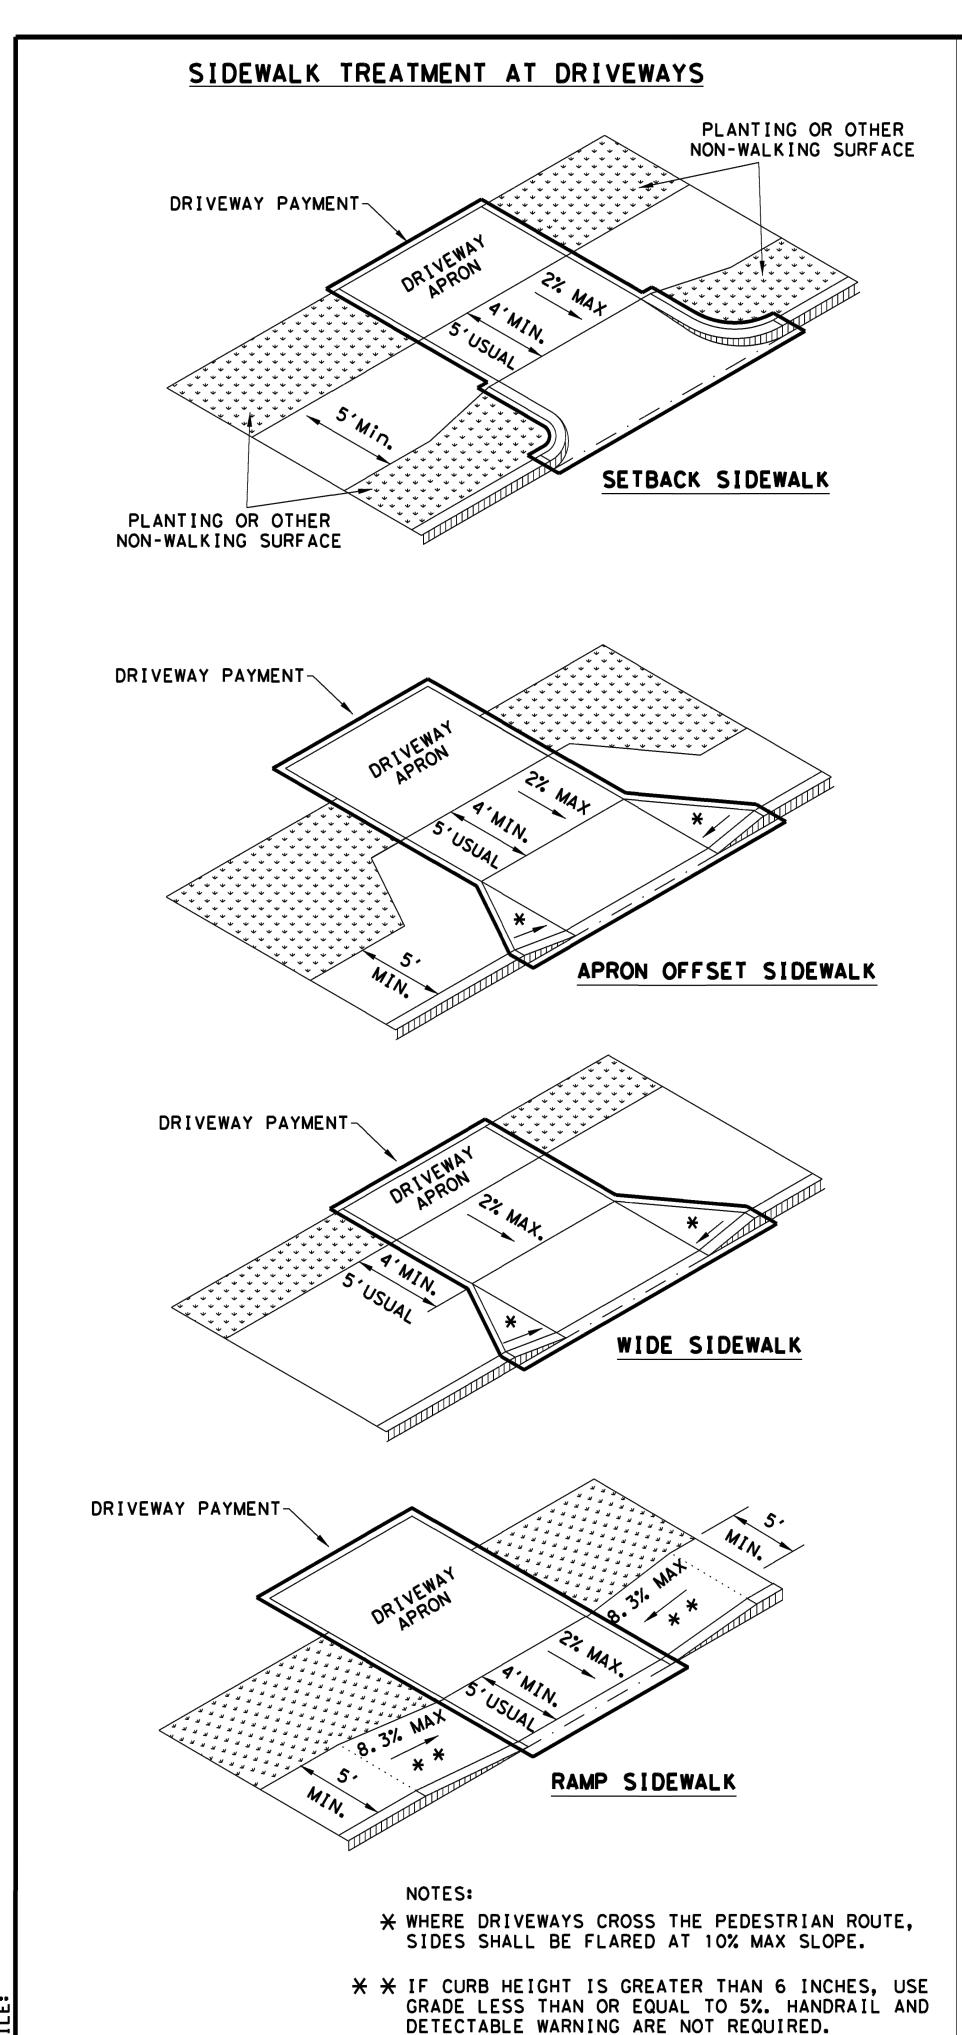

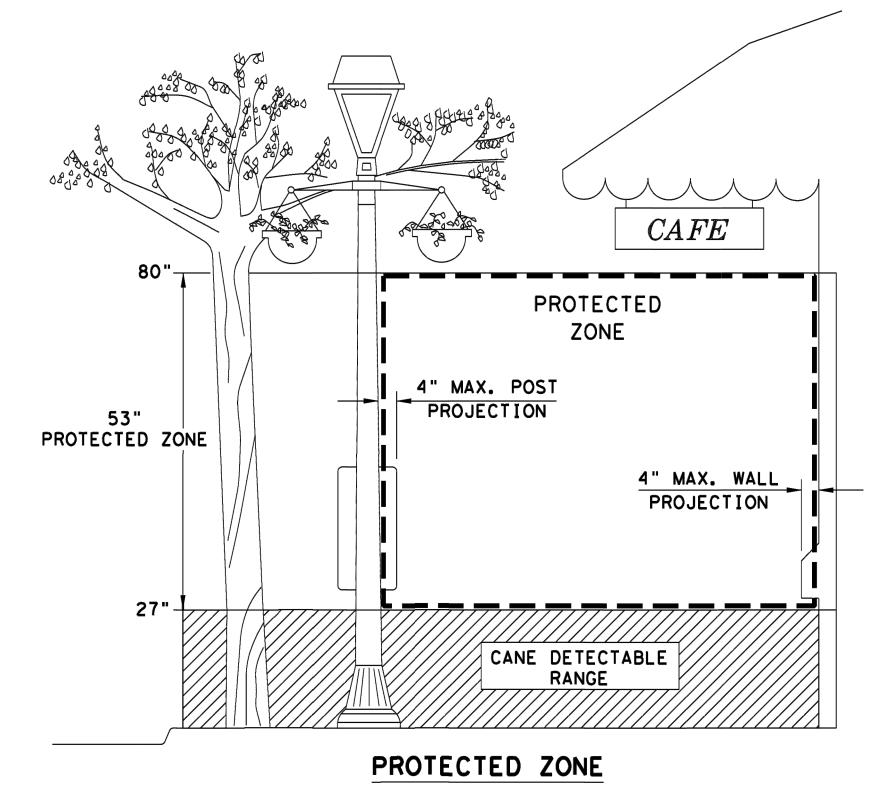


NOTE: IN PEDESTRIAN CIRCULATION AREA, MAXIMUM 4" PROJECTION FOR POST OR WALL MOUNTED OBJECTS BETWEEN 27" AND 80" ABOVE THE SURFACE.

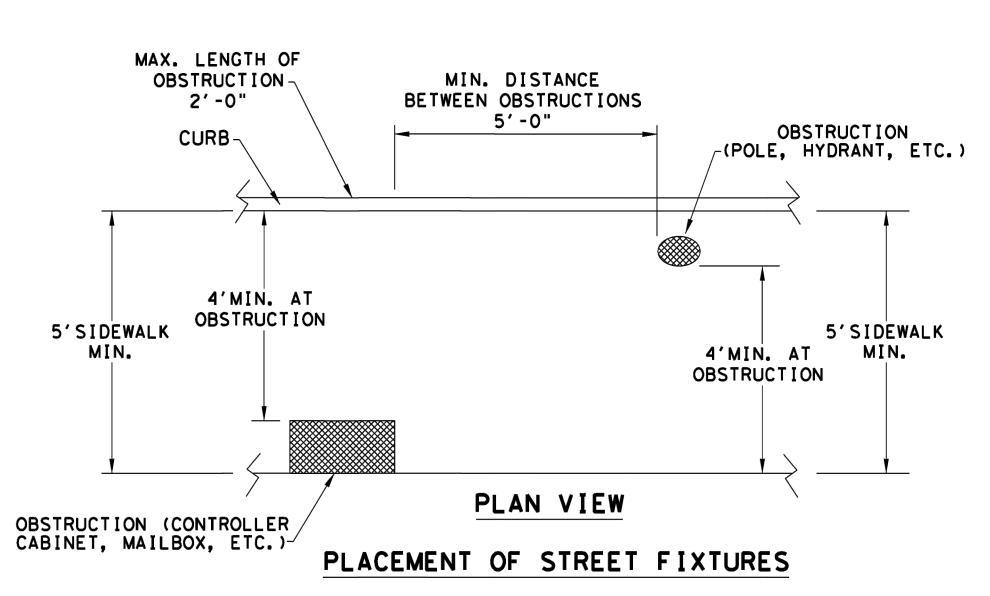


NOTE: ITEMS NOT INTENDED FOR PUBLIC USE.
MINIMUM 4' X 4' CLEAR GROUND SPACE
REQUIRED AT PUBLIC USE FIXTURES.

NOTE:
PED-18, SHEETS 1 THRU 4 ARE INTENDED TO BE USED AS
GENERAL GUIDELINES FOR THE CONSTRUCTION OF CURB RAMPS
FOR PEDESTRIAN FACILITIES. APPROX. INFORMATION FOR THE
CONSTRUCTION OF THESE FACILITIES ARE SHOWN ELSEWHERE
IN THE PLANS. ALL ADA/TAS REGULATIONS MUST APPLY

ALL EXPOSED NEW CONCRETE SURFACES SHALL HAVE A LIGHT BROOM FINISH.

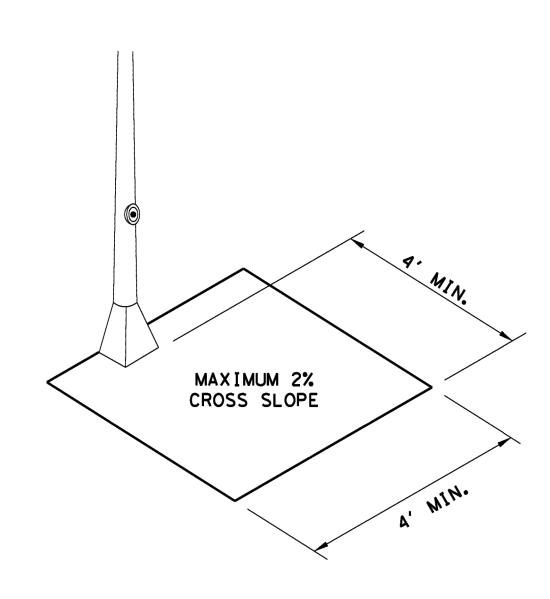

CLEAR SPACE ADJACENT TO PEDESTRIAN PUSH BUTTON

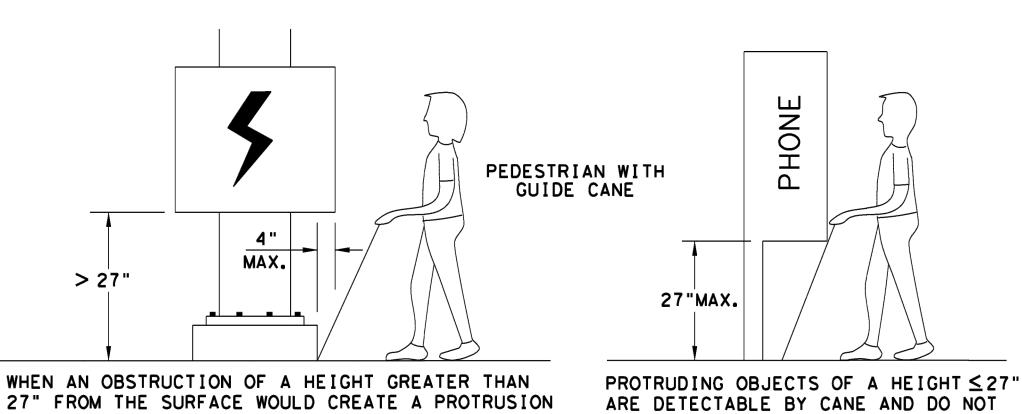

27" FROM THE SURFACE WOULD CREATE A PROTRUSION OF MORE THAN 4" INTO THE PEDESTRIAN CIRCULATION AREA, CONSTRUCT ADDITIONAL CURB OR FOUNDATION AT THE BOTTOM TO PROVIDE A MAXIMUM 4" OVERHANG.

DETECTION BARRIER FOR VERTICAL CLEARANCE < 80"



REQUIRE ADDITIONAL TREATMENT.



PEDESTRIAN FACILITIES CURB RAMPS


Standard

PED-18


FILE: ped18	DN: Tx	:DOT	DW: VP CK:		KM	M CK: PK & JG	
© TxDOT: MARCH, 2002	CONT	SECT	JOB			HIGHWAY	
REVISIONS REVISED 08,2005							
REVISED 06, 2012 REVISED 01, 2018	DIST	COUNTY				SHEET NO.	
•						23 of 27	

A TE:


TYPICAL CROSSING LAYOUTS SEE SHEET 1 OF 4 FOR DETAILS AND DIMENSIONS

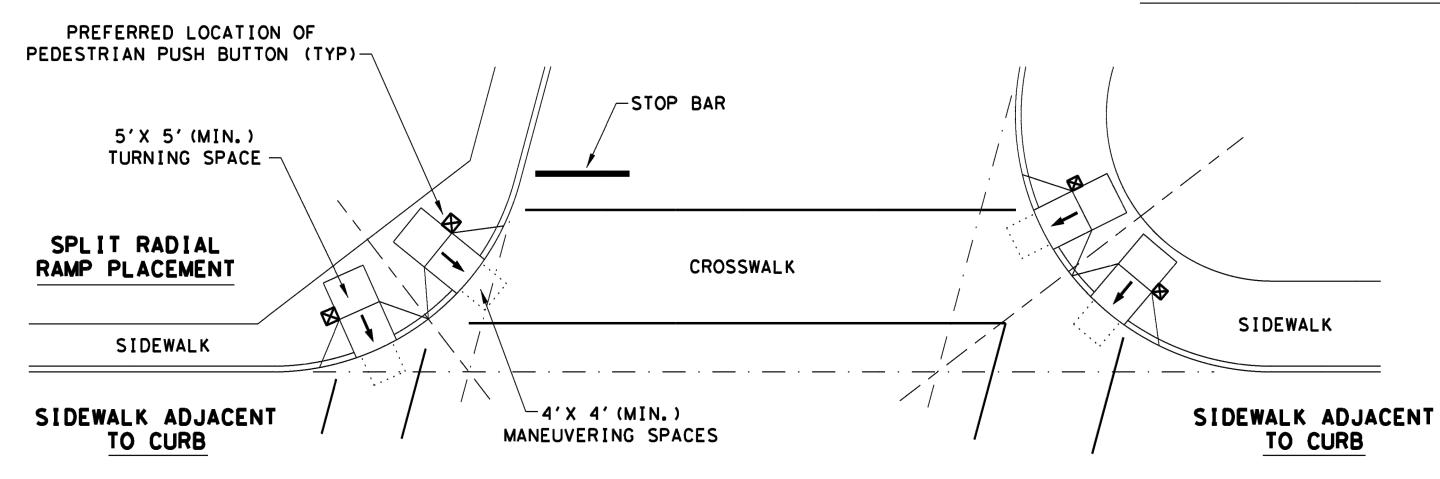

SKEWED INTERSECTION WITH "LARGE" RADIUS

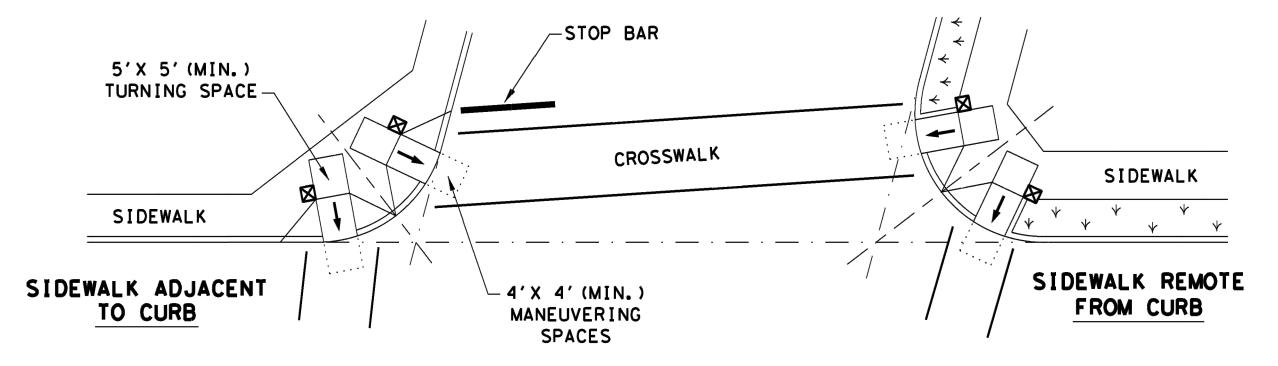


SKEWED INTERSECTION WITH "SMALL" RADIUS

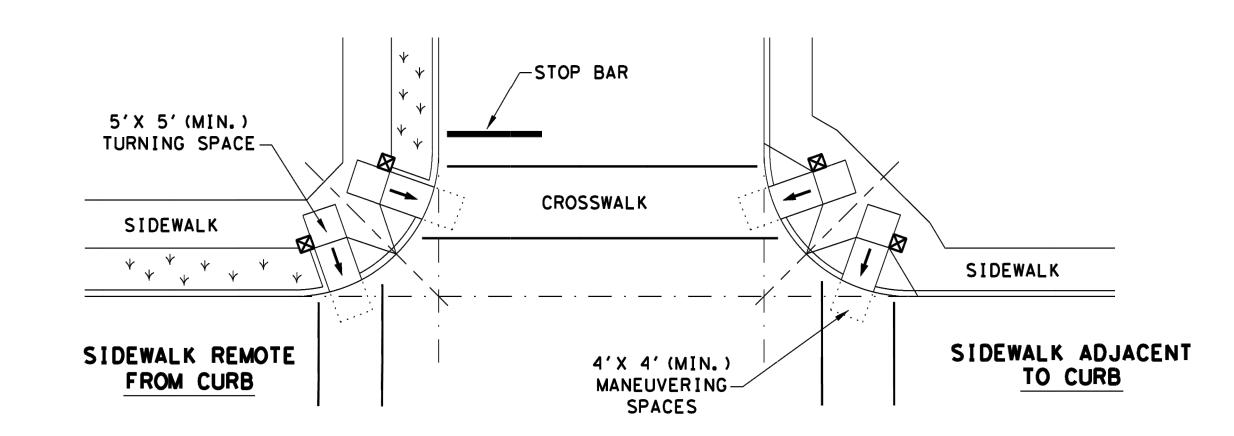


NORMAL INTERSECTION WITH "SMALL" RADIUS

NOTE:
PED-18, SHEETS 1 THRU 4 ARE INTENDED TO BE USED AS GENERAL GUIDELINES FOR THE CONSTRUCTION OF CURB RAMPS FOR PEDESTRIAN FACILITIES. APPROX. INFORMATION FOR THE CONSTRUCTION OF THESE FACILITIES ARE SHOWN ELSEWHERE IN THE PLANS. ALL ADA/TAS REGULATIONS MUST APPLY

ALL EXPOSED NEW CONCRETE SURFACES SHALL HAVE A LIGHT BROOM FINISH.

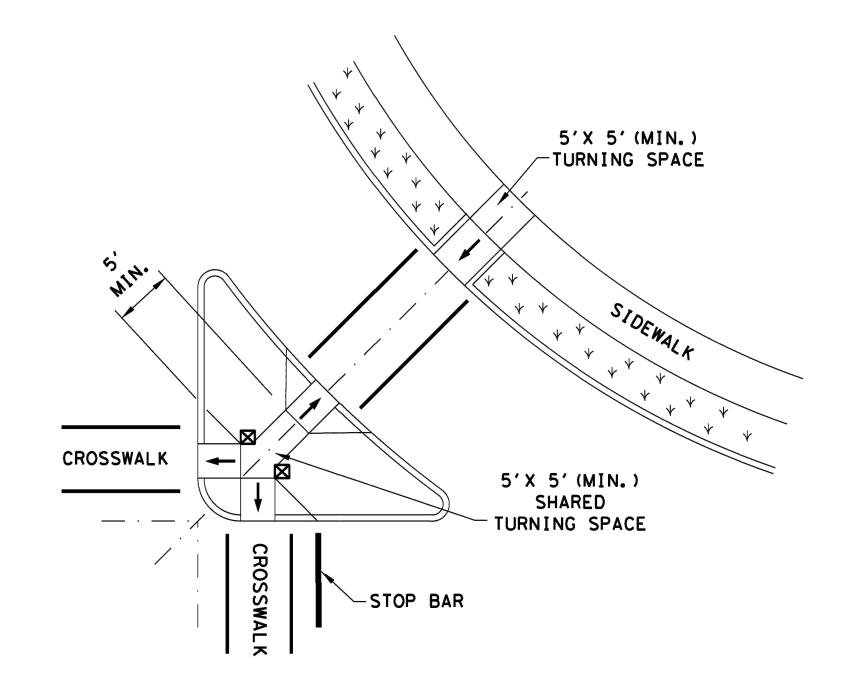



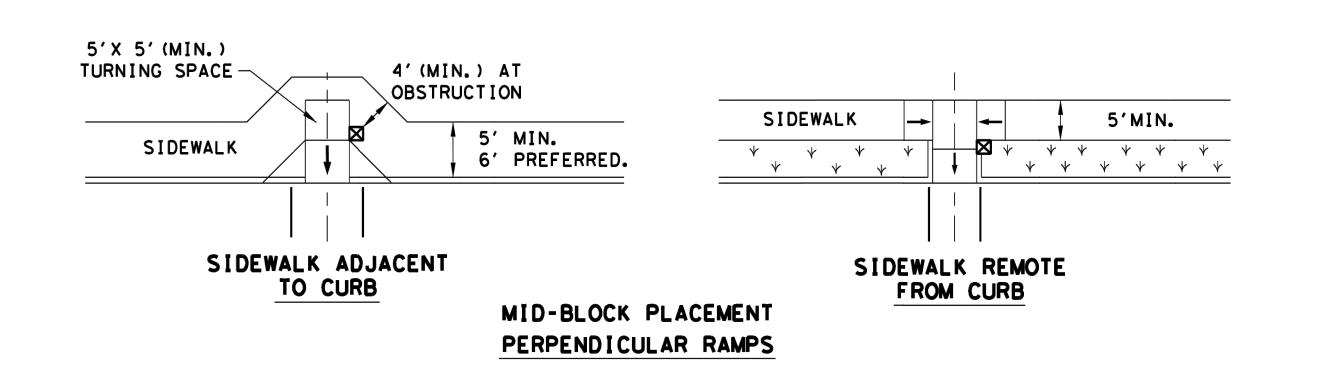

LEGEND:

SHOWS DOWNWARD SLOPE.

DENOTES PREFERRED LOCATION OF PEDESTRIAN PUSH BUTTON (IF APPLICABLE).

DENOTES PLANTING OR NON-WALKING SURFACE NOT PART OF PEDESTRIAN CIRCULATION PATH.

K K K K K K K K

	SHEET 4 OF 4	
®		
Texas Depart	ment of Transportat	ion

Design Division


PEDESTRIAN FACILITIES CURB RAMPS

PED-18

FILE: ped18	DN: Tx	DOT	OT DW: VP CK		KM CK: PK & JG	
© TxDOT: MARCH, 2002	CONT	SECT	JOB			HIGHWAY
REVISIONS REVISED 08,2005						
REVISED 06, 2012 REVISED 01, 2018	DIST	COUNTY				SHEET NO.
,						24 of 27


SHEET 25

OF **27** SHEETS

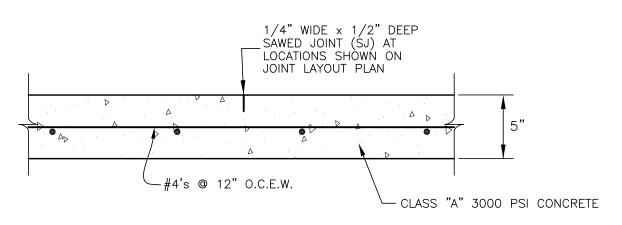


CONCRETE FLATWORK DETAIL

SEE JOINT LAYOUT PLAN FOR LOCATIONS (SJ)

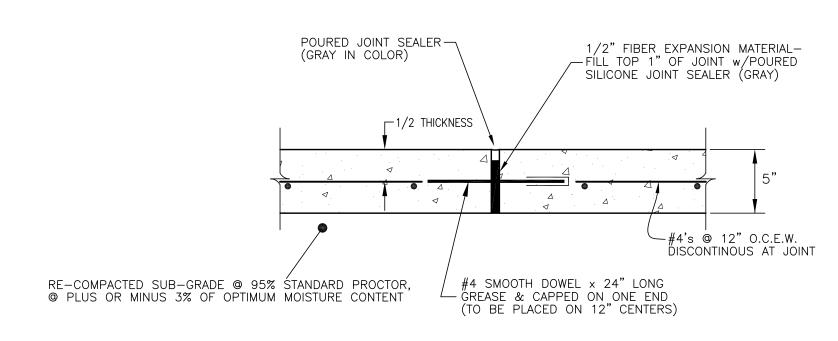


CONCRETE FLATWORK **EXPANSION JOINT DETAIL**


SEE JOINT LAYOUT PLAN FOR LOCATIONS (EJ)

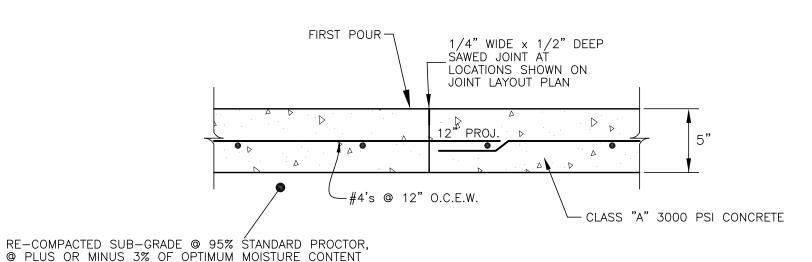

CONCRETE FLATWORK CONSTRUCTION JOINT DETAIL

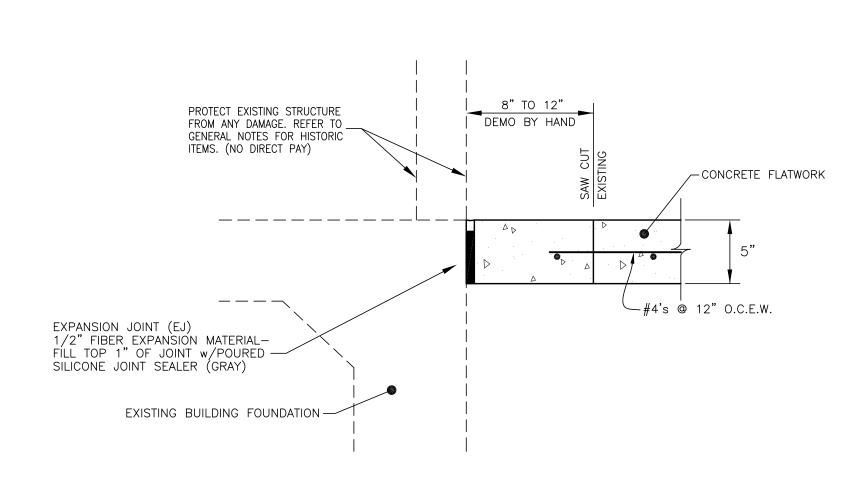

EXISTING BLDG. AT FLATWORK CONSTRUCTION/EXPANSION JOINT DETAIL (EJ)

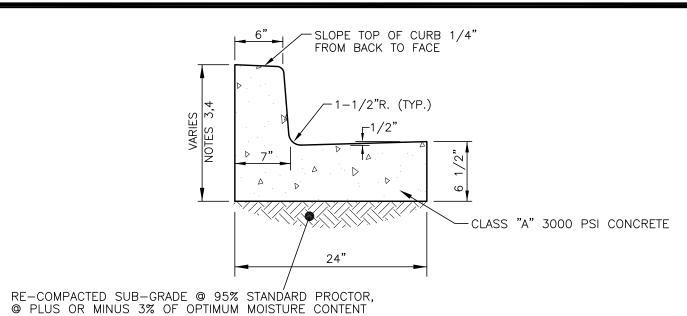


EXPANSION JOINTS TO HAVE TWO #4 SMOOTH DOWELS x 24" LONG GREASE & CAPPED ON ONE END (TO BE PLACED ON 12" CENTERS)

24" CONCRETE CURB & GUTTER

WITH 1/2" FIBER EXPANSION MAT'L

1. EXPANSION JOINTS TO BE PLACED AT 50' CENTERS.


- 2. TOOLED JOINTS TO BE PLACED AT 5' CENTERS AND AT P.C.'s AND P.T.'s. 3. SEE PROPOSED LAYOUT AND GRADING PLANS FOR
- PROPOSED CURB GRADES.
- 4. CURB HEIGHT MAY BE ADJUSTED SLIGHTLY TO MATCH EXISTING FIELD CONDITIONS, WHILE MAINTAINING ADA COMPLIANCE WHERE APPLICABLE.

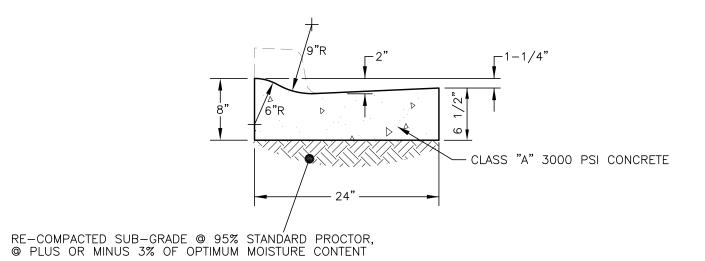

EXPANSION JOINTS TO HAVE TWO #4 SMOOTH DOWELS x 24" LONG GREASE & CAPPED ON ONE END (TO BE PLACED ON 12" CENTERS) WITH 1/2" FIBER EXPANSION MAT'L

24" LAYDOWN CURB & GUTTER

1. EXPANSION JOINTS TO BE PLACED AT 50' CENTERS. 2. TOOLED JOINTS TO BE PLACED AT 5' CENTERS AND AT P.C.'s AND P.T.'s.

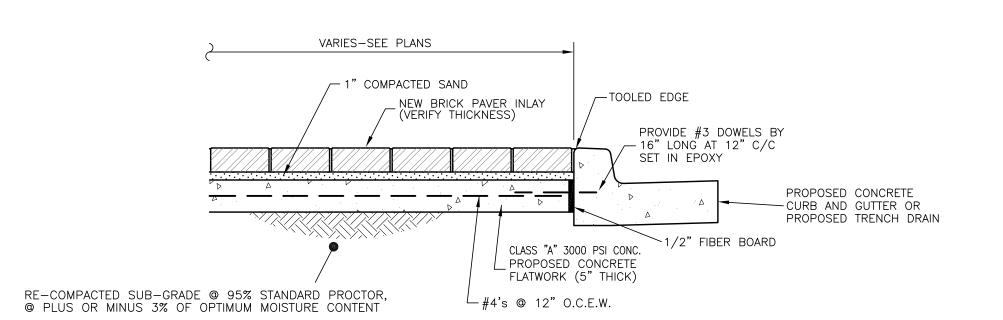

VARIES-SEE PLANS

RE-COMPACTED SUB-GRADE @ 95% STANDARD PROCTOR,

@ PLUS OR MINUS 3% OF OPTIMUM MOISTURE CONTENT

1" COMPACTED SAND

NEW BRICK PAVER INLAY (VERIFY THICKNESS)

TYPICAL BRICK PAVER INLAY SECTION

(IN CONCRETE FLATWORK)

SAWED, EXPANSION & CONSTRUCTION JOINTS TO EXTEND THRU CONCRETE

UNDER BRICK INLAY AREAS-SEE JOINT LAYOUT PLAN

-4" TOOLED EDGE FRAME

PROPOSED CONCRETE FLATWORK (5" THICK)


CLASS "A" 3000 PSI CONC.

PROPOSED CONCRETE FLATWORK (5" THICK)

-#4's @ 12" O.C.E.W.

TYPICAL BRICK PAVER INLAY SECTION

(AT CURB & GUTTER) (SAME APPLIES AT LIGHT FIXTURE FOUNDATIONS) SAWED, EXPANSION & CONSTRUCTION JOINTS TO EXTEND THRU CONCRETE UNDER BRICK INLAY AREAS-SEE JOINT LAYOUT PLAN

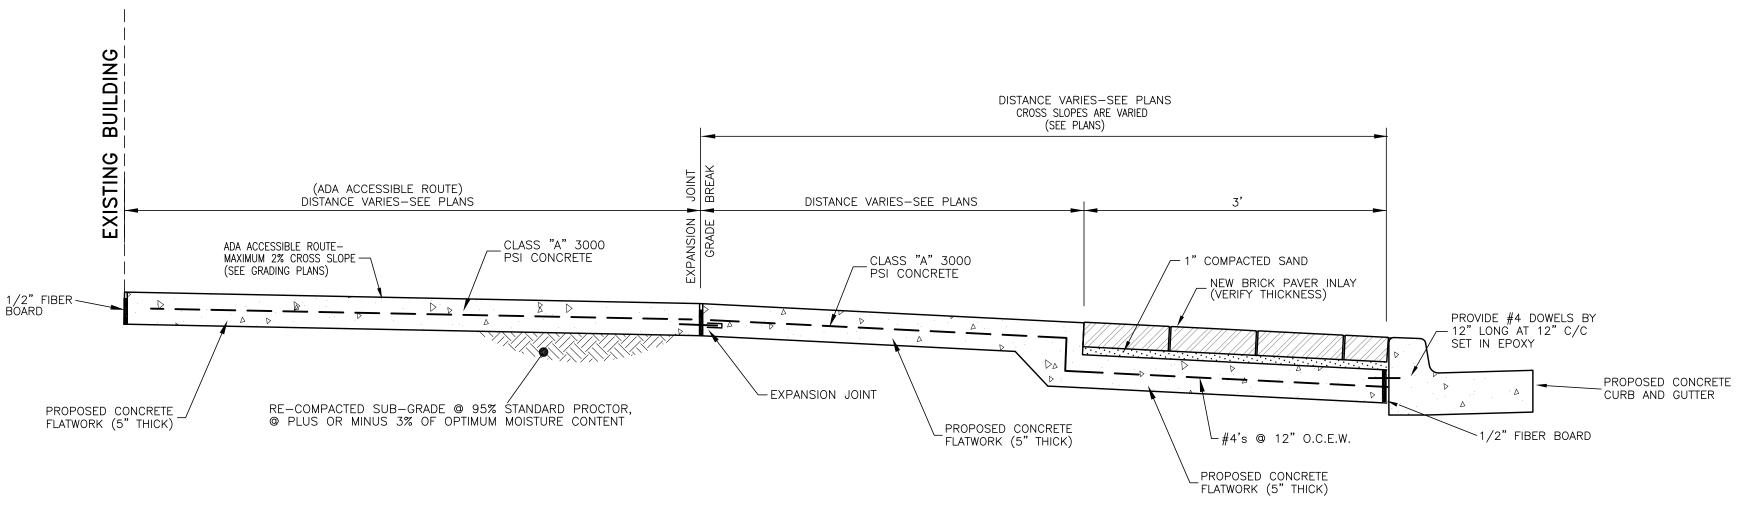

TYPICAL SIDEWALK CROSS SECTION

ALL EXPOSED NEW CONCRETE SURFACES SHALL HAVE A LIGHT BROOM FINISH.




R.L.C. DRAWN BY: CHECKED BY : S.R.H. DATE : **SEPT. 2023** SCALE : AS NOTED JOB NO. : MA-21-01 MA-22-04

SHEET

N.T.S.

ALL EXPOSED NEW CONCRETE SURFACES SHALL HAVE A LIGHT BROOM FINISH.

OF **27** SHEETS

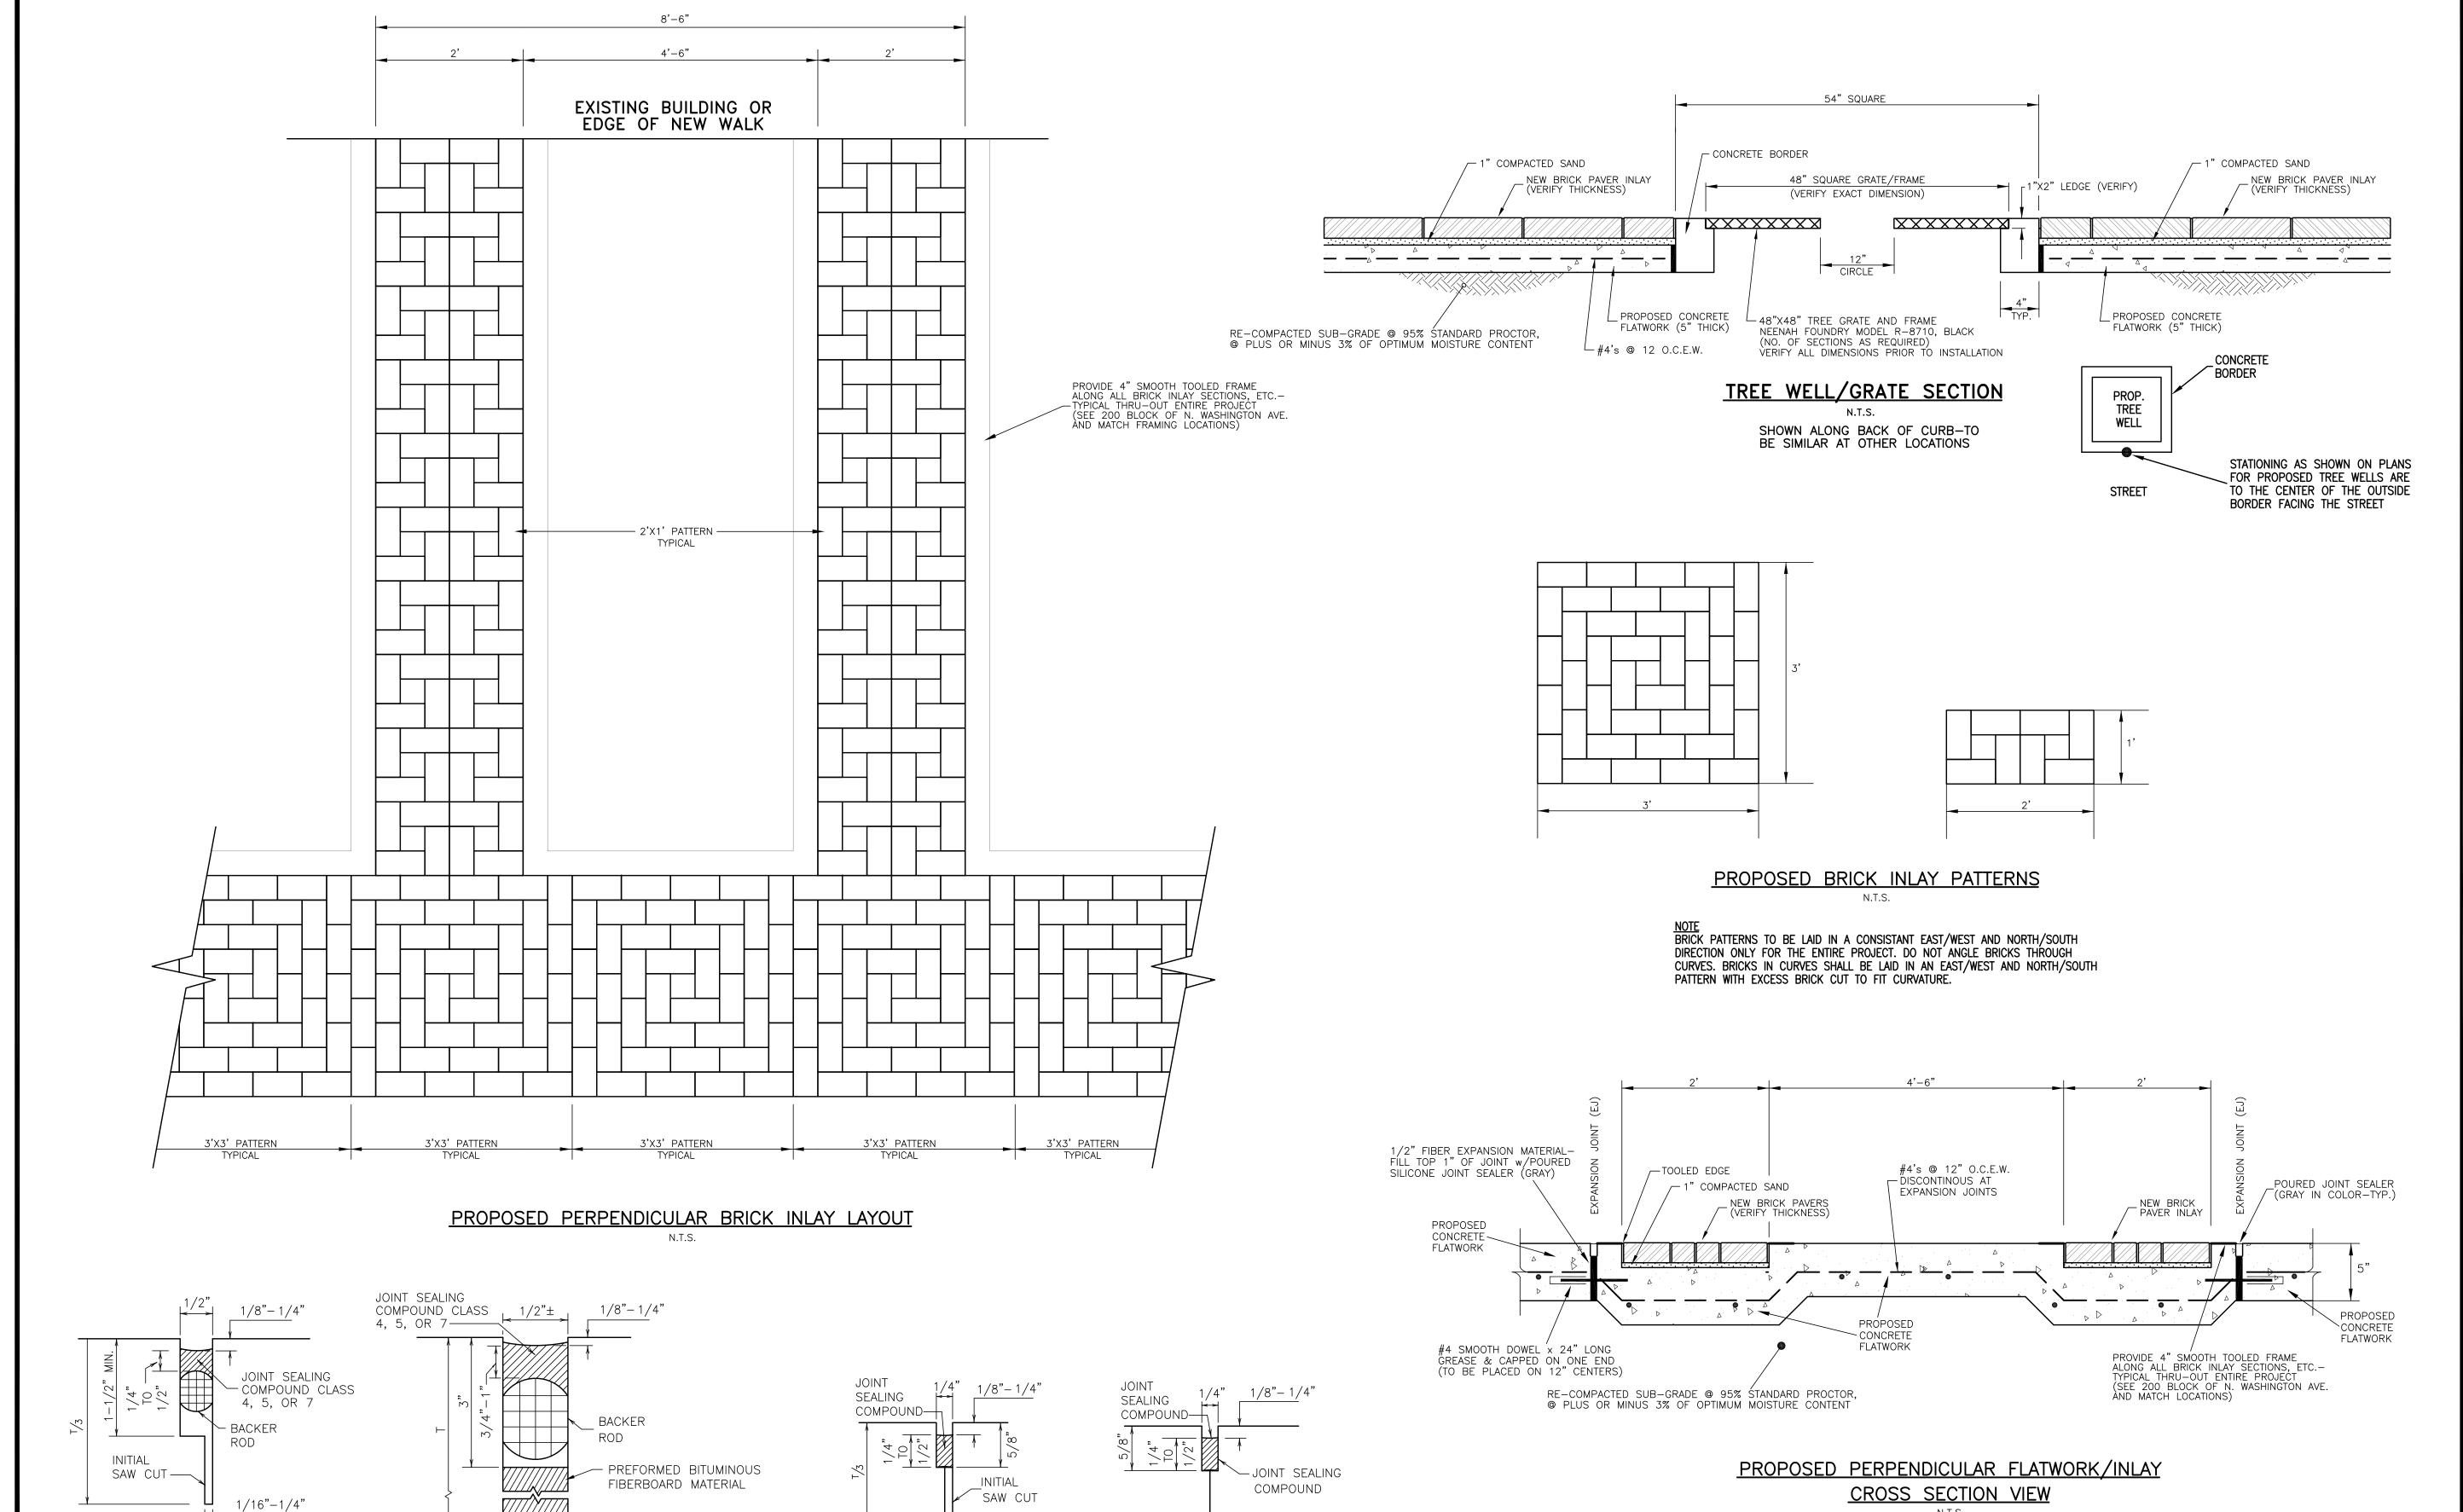

LONGITUDINAL

CONSTRUCTION JOINT

1/16"-1/4"

LONGITUDINAL JOINT SEALS

SAWED

LONGITUDINAL JOINT

SAWED

CONTRACTION JOINT

FORMED

EXPANSION JOINT

TRANSVERSE JOINT SEALS

DRAWN BY: R.L.C.

CHECKED BY: S.R.H.

DATE: SEPT. 2023

SCALE: AS NOTED

JOB NO.: MA-21-01
MA-22-04

SHEET **27**

of **27** sheets

SEE NOTE 3

10' TRANS.

TYP. BOTH SIDES


6" 6" 6" 7 1/2"

VARIES

FER PLAN


6" SAND BASE OR MUDSLAB (NDP)

SECTION "A"

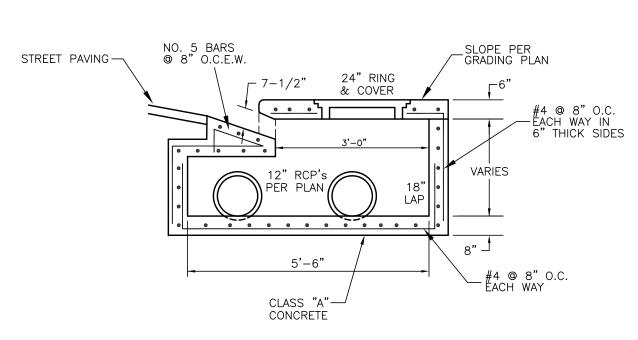

SECTION "B"


CONTRACTOR TO ADD ADDITIONAL STEEL REINFORCING AS REQUIRED IN CURB AND GUTTER THROAT SECTION TO PROVIDE A SAFE, STRUCTURAL SPAN OF THE 5' BOX EXTENSION OPENING.

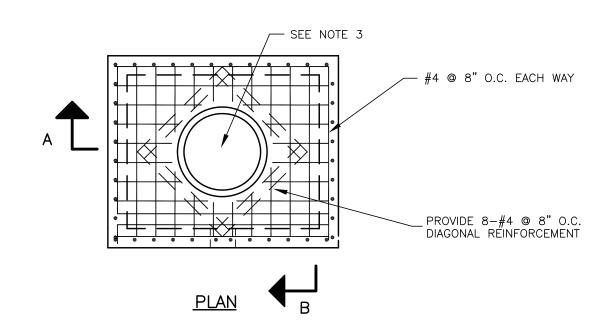


5' STORM SEWER CURB INLET WITH BOX EXTENSION

NOTE


- 1. ALL EXPOSED CONCRETE EDGES TO BE CHAMFERED 3/4".
- 2. 6" INLET THROAT SUPPORT IS REQ'D FOR 10', 15', AND 20' INLETS. SUPPORTS SHALL BE SPACED AT 5'-0" C/C. 6" INLET THROAT SUPPORT SHALL BE REINFORCED WITH 2 #4 BARS TIED TO INLET TOP AND WALLS. DEVELOPMENT LENGTH SHALL BE 12" MIN. (SEE DETAIL)
- 3. INLET MANHOLE RING AND COVER SHALL BE CENTERED IN TOP OF INLET WIDTH, OFFSET FROM THE INLET THROAT AS REQ'D.4. PROVIDE NON-SHRINK GROUT FLOW SLOPES BETWEEN ALL PIPES ENTERING AND EXITING INLET BOX.

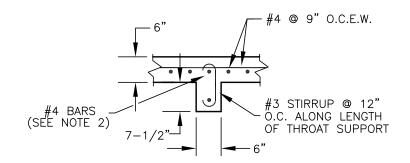

DETAIL @ 6" INLET THROAT SUPPORT

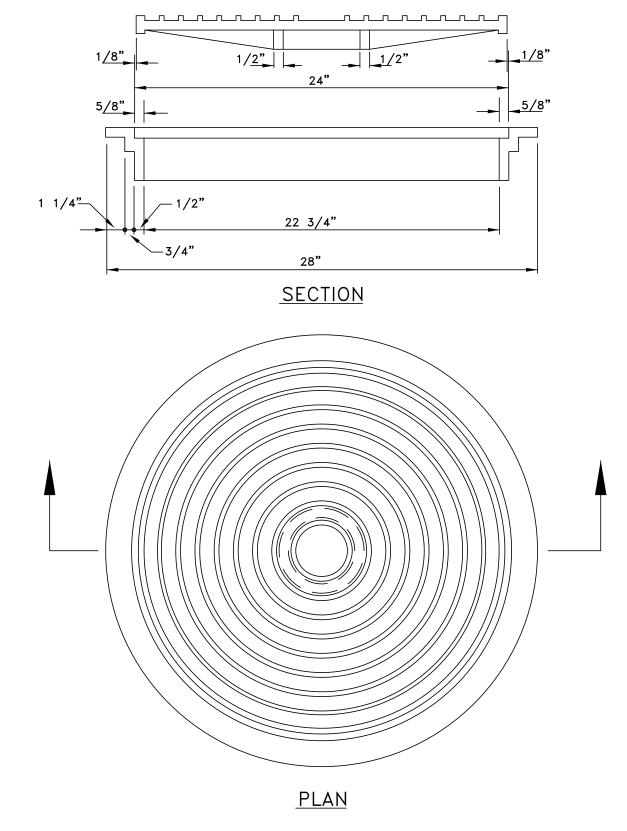


INLET MANHOLE, RING & COVER

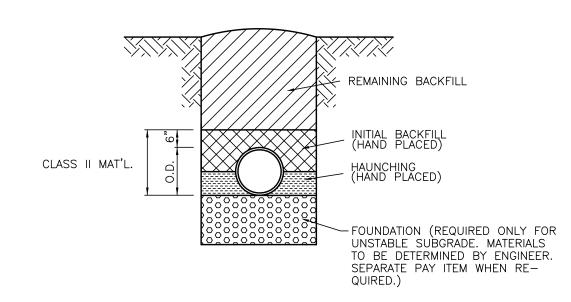

STORM SEWER-RIGID PIPE CLASS II EMBEDMENT

(TO BE USED FOR RIGID PIPE EXCEPT AS NOTED ON PLANS)

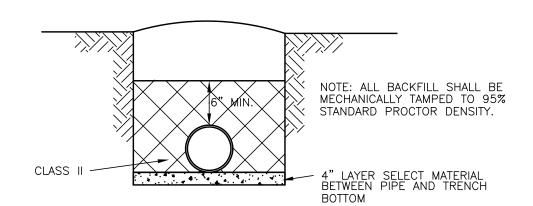


STORM SEWER TYPE 2 LAYING CONDITION


(USE FOR ROCKY OR HARD TRENCH BOTTOM)

CLASS I:
LOW PI GRANULAR MATERIAL (CLEAN SAND)
UP TO 3/4"-1 1/2" GRADED STONE
INCLUDING A NUMBER OF FILL MATERIALS
THAT HAVE REGOINAL SIGNIFICANCE SUCH
AS CORAL, SLAG, CINDERS, CRUSHED
STONE AND CRUSHED SHELLS.

CLASS II:
SUITABLE NATIVE MATERIAL INCLUDING
FINE SANDS, SANDY CLAY MIXTURE
AND GRAVEL CLAY MIXTURE.

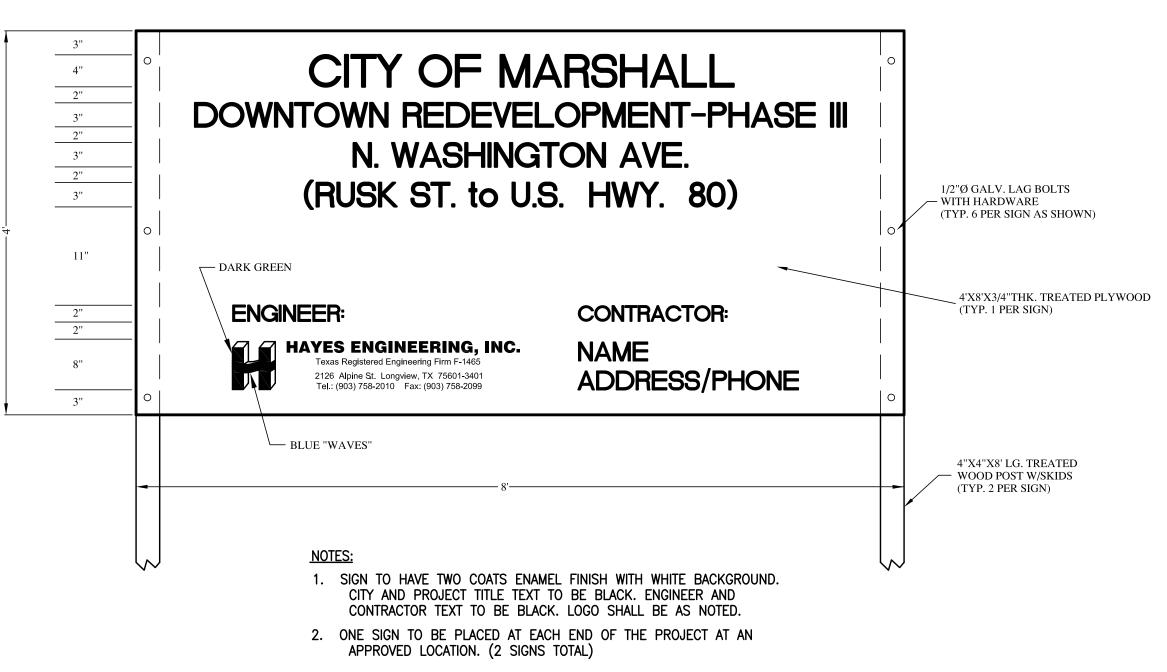

PROJECT SIGN DETAIL

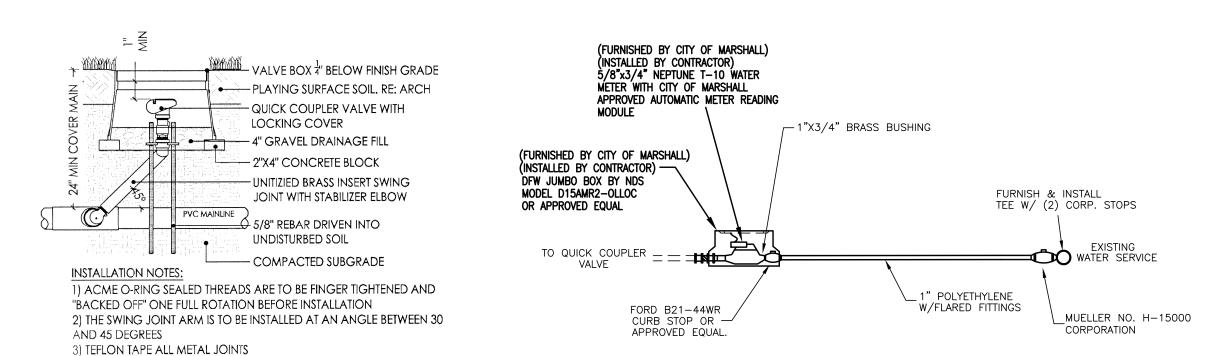

QUICK COUPLER VALVE


CONTRACTOR TO COORDINATE EXACT LOCATION

AND PLACEMENT OF TRAFFIC RELATED SIGNS

WITH THE CITY OF MARSHALL STREET DEPT.


NEW SIGN POST ASSEMBLY

(N.T.S.)

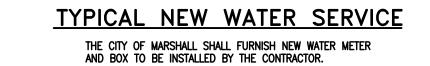

ALL EXPOSED NEW CONCRETE SURFACES

SHALL HAVE A LIGHT BROOM FINISH.

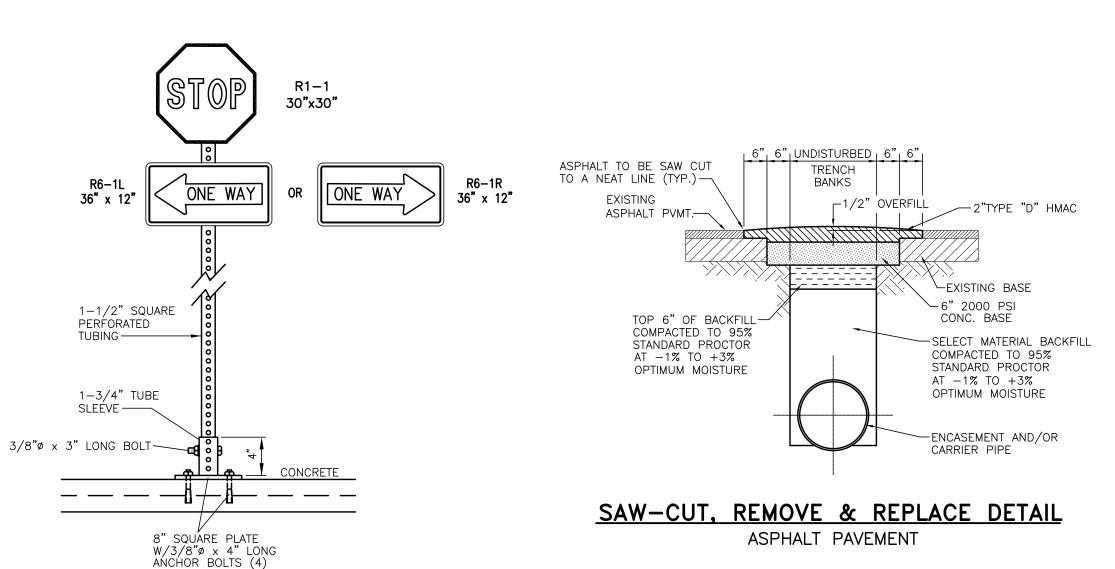



CHECKED BY : W.W.J. DATE : **OCT. 2023** SCALE : AS NOTED JOB NO. : MA-21-01 MA-22-04

3 SHEETS

GROUND GRID NOTES GN1 INSTALL 3/4" x 30' SECTIONALIZED COPPERCLAD STEEL GROUND ROD. GN2 INSTALL 3/4" x 10' COPPERCLAD STEEL GROUND ROD.

GN3 INSTALL 3/4" SCHEDULE 40 PVC PLASTIC CONDUIT WITH (1)-#4 AWG COPPER GROUNDING ELECTRODE CONDUCTOR BETWEEN ELECTRICAL EQUIPMENT AND GROUND GRID.

GN4 MAKE ALL CONNECTIONS USING EXOTHERMIC WELDING (CADWELD) PROCESS.

GN5 INSTALL 3/4" SCHEDULE 40 PVC PLASTIC CONDUIT WITH (1)-#1/0 AWG COPPER GROUNDING ELECTRODE CONDUCTOR BETWEEN ELECTRICAL EQUIPMENT AND GROUND GRID.

IT SHALL BE THE CONTRACTORS RESPONSIBILITY TO INVESTIGATE SUBSURFACE SITE CONDITIONS AND BECOME FAMILIAR WITH THE SHALL PROVIDE EQUIPMENT AS NECESSARY TO ACCOMPLISH THE

STEP 1) DRIVE THE GROUND RODS TO THE FULL 30' DEPTH. IF THE GROUND RODS CANNOT BE DRIVEN THEN THEY SHALL BE INSTALLED

RESULT IN THE REPLACEMENT OF THE ENTIRE GROUNDING SYSTEM.

GROUND ROD INSTALLATION NOTES

REQUIREMENTS OF INSTALLING 30' GROUND RODS. THE CONTRACTOR

STEP 2) BORE A 6" DIAMETER X 30'PLUS DEEP GROUND WELL BY WHATEVER MEANS NECESSARY. INSTALL 30' GROUND ROD (THREE 10' SECTIONS SCREWED TOGETHER) INTO CENTER OF WELL. BACKFILL AND TAMP AROUND ROD WITH ERICO "GEM" COMPOUND TO WITHIN 24" OF GRADE. FINISH BACKFILL WITH SELECT TOPSOIL AFTER CONNECTION OF GROUNDING ELECTRODE CONDUCTOR(S).

THE INSTALLATION OF THE GROUND RODS AND GROUNDING GRID SHALL BE SCHEDULED IN ADVANCE SO THAT IT CAN BE WITNESSED BY THE OWNER OR HIS REPRESENTATIVE. FAILURE TO DO SO MAY

LCP POWER , O LP1-LP3 LIGHTS SPARE Ó , O LP4-LP6 LIGHTS O LP1-LP3 UPPER RECEPTACLES LP1-LP3 LOWER RECEPTACLES LP4-LP6 LOWER RECEPTACLES 6 , O LP4-LP6 UPPER RECEPTACLES O SPARE RECEPTACLE * 6 SPARE Ó

ELECTRICAL

-LEGEND-

A - HOME RUN FROM DEVICE TO PANEL 3/4"C. MIN. (UNO) - NO MORE THAN 3 CONDUCTORS PER CONDUIT WITHOUT DERATING. 20A CIRCUIT - #12 THWN COPPER, 30A CIRCUIT - #10 COPPER

EATON "CLIPPER" OR ENGINEER ACCEPTED EQUIVALENT

GROUND ROD, COPPER WELD, SIZE AND LENGTH AS NOTED

JB - JUNCTION BOX OR PULL BOX - SIZE AS NOTED OR PER NEC IF NOT NOTED

□ → DUPLEX RECEPTACLE, 125V, 20A, NEMA → 5-20R

ФОR — DISCONNECT SWITCH - SIZE AND TYPE AS NOTED 600 AMP

⇔ WP/GFI - GROUND FAULT INTERRUPTER RECEPTACLE (WP) - W/WEATHERPROOF COVER

600AF ☐ - FUSE - 600 AMP DENOTED

 $\frac{1}{1}$ C - CONTACTOR - SIZE AS INDICATED ••• − COIL − VOLTAGE AS INDICATED

(A) - LIGHT FIXTURE, MARK "A" DENOTED

---- CONCEALED OR UNDERGROUND CONDUIT

SURGE PROTECTIVE DEVICE

GEC - GROUNDING ELECTRODE CONDUCTOR

EGC - EQUIPMENT GROUNDING CONDUCTOR

- CIRCUIT BREAKER

------ - EXPOSED CONDUIT

SPD - 120/240V., 3ø,4W

WP - WEATHER PROOF

NIC - NOT IN CONTRACT

– EXISTING POLE O - PROPOSED POLE

FBO - FURNISHED BY OTHERS

AFF - ABOVE FINISHED FLOOR

SS - STAINLESS STEEL, 316

HDG - HOT DIPPED GALVANIZED

BSDC - BARE SOFT DRAWN COPPER


FWE - FURNISHED WITH EQUIPMENT

LIGHTING PANEL "L1" SCHEDULE

100A, 120/240V, 1ø, 3W, 22 KAIC, 18 SPACE, NEMA-3R, PANEL SHALL BE LOCKABLE.

★ - GFCI

1) L2 @ SP#2 SHALL BE SIMILAR. 2) L3 @ SP#3 SHALL BE SIMILAR. 3) L4 @ SP#4 SHALL BE SIMILAR.

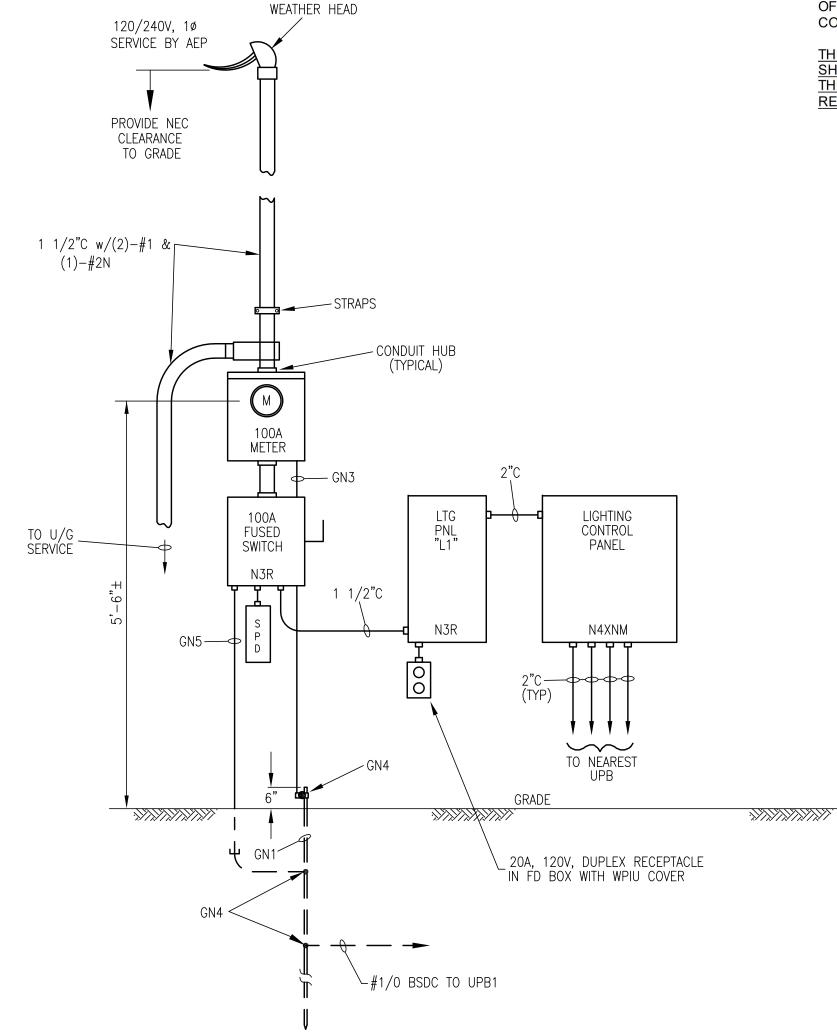

/HDG RIGID STEEL (GRS)

40 MIL PVC COATED -HDG STEEL CONDUIT

(PVC/GRS) (NOTE 1)

CONDUIT

`90°ÉL (NOTE 1)

GRADE →

24"MIN.

SCHEDULE 40 PVC PLASTIC

SAND BACK FILL

ADAPTER

TYPICAL CONDUIT DETAIL

1) U/G CONDUIT & ELBOWS BETWEEN U/G PULL BOXES

AND POLE BASES MAY BE SCHEDULE 40 PVC PLASTIC.

ILLUSTRATIVE SERVICE DETAIL

1. FURNISH & INSTALL SERVICE EQUIPMENT PER POWER CO. REQUIREMENTS. 2. ALL ELECTRICAL EQUIPMENT, MATERIALS AND INSTALLATIONS SHALL BE

PER APPLICABLE ELECTRIC CODES AND CITY OF MARSHALL, TX. ORDINANCES. 3. MOUNT PROPOSED EQUIPMENT ON EXISTING BUILDING WALL USING HDG UNISTRUT P-1000 & 316 SS HARDWARE.

FOLLOWING STEPS:

SE INC. M F-2490





CHECKED BY : W.W.J. DATE : **OCT. 2023** SCALE : AS NOTED

JOB NO. : MA-21-01
MA-22-04

SHEET

OF **3** SHEETS

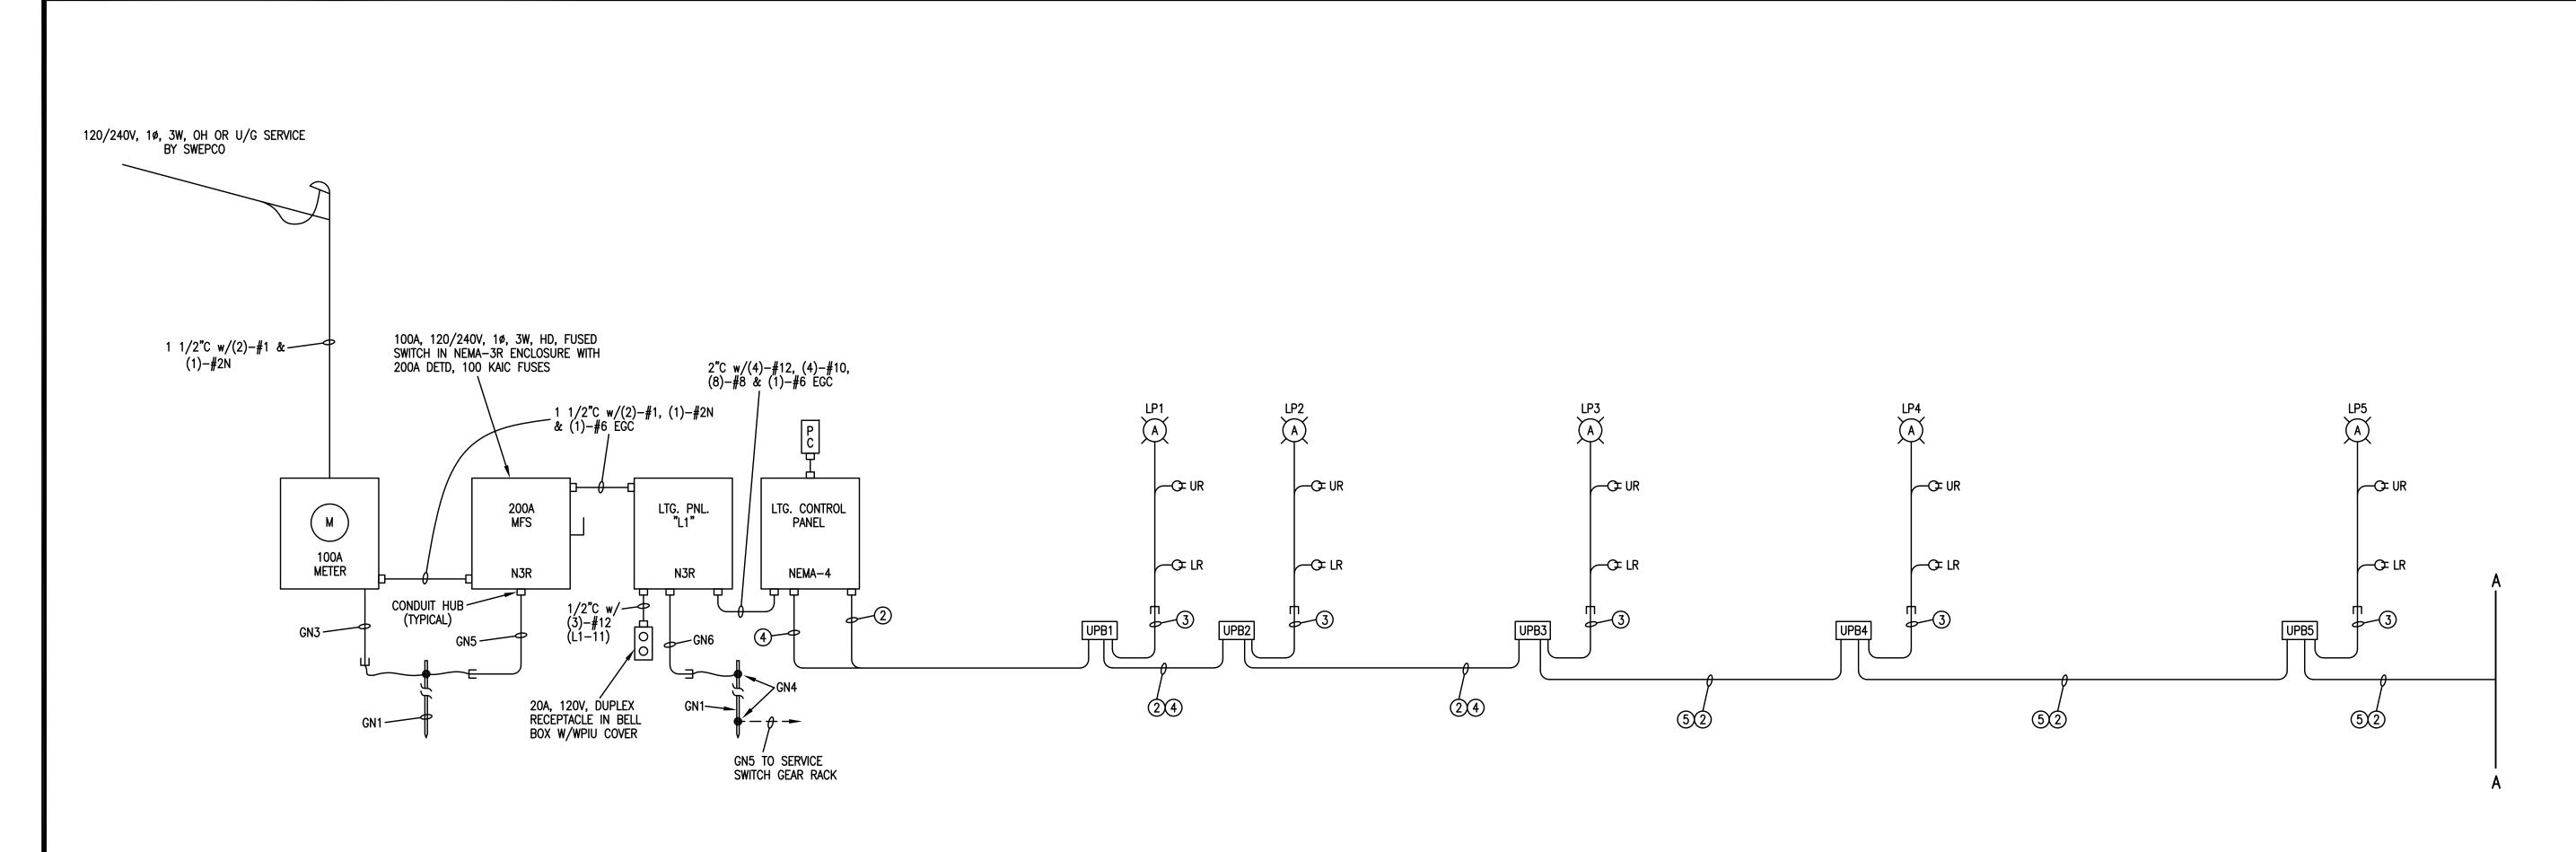

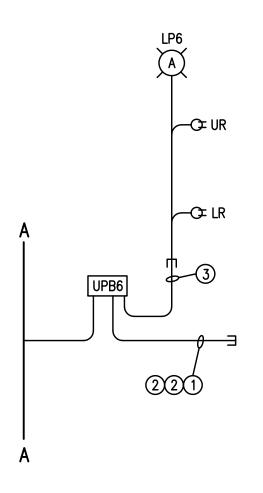

TYPICAL ELECTRICAL SCHEMATIC

UR — UPPER RECEPTACLE LR — LOWER RECEPTACLE

1) LP1-LP6 SHOWN. LP7-LP12 SIMILAR. LP13-LP18 SIMILAR. LP19-LP24 SIMILAR

1 — STUBOUT CONDUITS & CAP FOR FUTURE EXTENSION

4 — 2"C W/(4)-#10 (LTG), (4)-#8 (UR), (4)-#8 (LR) & (1)-#6 EGC


 \bigcirc – 2°C (EMPTY)

(5) — 2"C W/(2)-#10 (LTG), (2)-#8 (UR), (2)-#8 (LR) & (1)-#6 EGC

SE INC. M F-2490






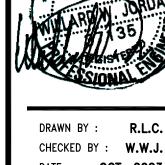


DRAWN BY: R.L.C. CHECKED BY : W.W.J. DATE : **OCT. 2023** SCALE : AS NOTED JOB NO. : MA-21-01 MA-22-04

of **3** sheets

SPD (NOTE 8) (NOTE 1) PHOTOCELL CR2 (NOTE 2) PHOTO / ASTRO ASTRONOMIC TIMER
INTERMATIC V45471CR (NOTE 3) SWITCHES LIGHTS (0,0,X,0)(0,0,X,0)CR2

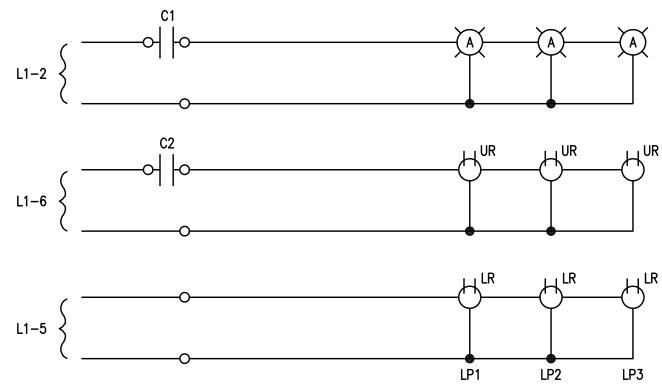

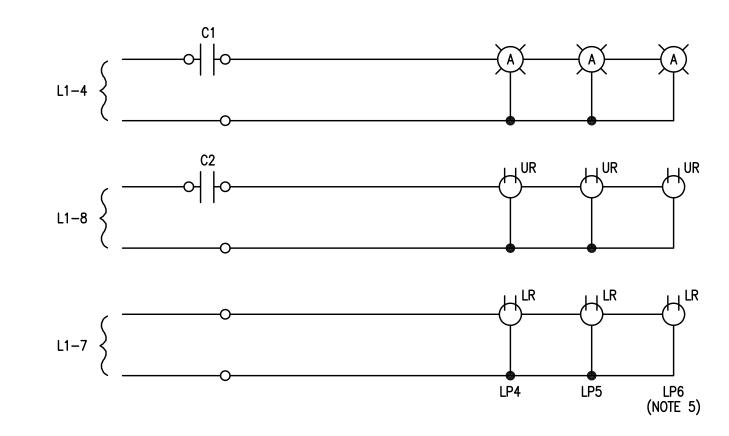

<u>LP1-LP6</u> LIGHTS & RECEPTACLES CONTROL DIAGRAM N.T.S.

NOTE 1: CR1-4 POLE, 10A, 120V COIL, MACHINE TOOL RELAY ENERGIZED WHEN AMBIENT LIGHT IS AT DUSK OR DARKER.

NOTE 2: CR2-4 POLE, 10A, 120V COIL, MACHINE TOOL RELAY ENERGIZED WHEN TIMER CONTACT CLOSES. NOTE 3: TC-TIMER CONTACT IN ASTRONOMIC TIMER.

NOTE 4: C1/C2-30A, 4P, ELECTRICALLY HELD, 240V, WITH 120VAC COIL.

NOTE 5: LP1-LP6-EXISTING STREET LIGHT POLES.

NOTE 6: NOT USED NOTE 7: PHOTO-ELECTRIC SWITCH, TORK TWIST LOCK WITH RECEPTACLE.

NOTE 8: SPD1-SURGE PROTECTIVE DEVICE, MAXIVOLT, INC. MODEL ICP 110, OR EQUIVALENT.

NOTE 9: HOUSE COMPONENTS IN 24"X24"X10" NEMA-4 STEEL ENCLOSURE WITH HINGED INNER PANEL, BACK PANEL, HINGED

OUTER DOOR WITH QUICK DISCONNECT LATCHES AND HASP TO ACCOMMODATE A PAD LOCK.

NOTE 12: LIGHTS LP19-LP24 SHALL BE SIMILAR.

NOTE 10: LIGHTS LP7-LP12 SHALL BE SIMILAR. NOTE 11: LIGHTS LP13-LP18 SHALL BE SIMILAR.